EDISON STREET

S EDISON STREET AND 300 S SALT LAKE CITY, UTAH 84111

SCHEMATIC DESIGN - 7/14/23

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PROJECT INFORMATION

CONTRACTOR SHALL BE RESPONSIBLE FOR COMPLYING WITH APPLICABLE CODES OR STATUS WHETHER OR NOT SPECIFICALLY REFERENCED IN THE CONSTRUCTION DOCUMENTS

- 2021 EDITION OF THE INTERNATIONAL BUILDING CODE, INCLUDING APPENDICES C AND J
- 2021 EDITION OF THE INTERNATIONAL PLUMBING CODE, ISSUED BY THE INTERNATIONAL CODE COUNCIL
- 2021 EDITION OF THE INTERNATIONAL MECHANICAL CODE, ISSUED BY THE INTERNATIONAL CODE COUNCIL
- 2021 EDITION OF THE INTERNATIONAL FUEL GAS CODE, ISSUED BY THE INTERNATIONAL CODE COUNCIL
- 2020 EDITION OF THE NATIONAL ELECTRICAL CODE, ISSUED BY THE NATIONAL FIRE PROTECTION
- COMMERCIAL PROVISIONS OF THE 2021 EDITION OF THE INTERNATIONAL ENERGY CONSERVATION CODE, ISSUED BY THE INTERNATIONAL CODE COUNCIL

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VICINITY MAP



PROJECT RENDERING



1280 HIGHTOWER TRAIL ATLANTA, GA 30350 PHONE: 770.864.1035

EDISON STREET AND 300 S
SALT LAKE CITY, UTAH 84111

J-FISHER

ISSUE
DATE DESCRIPTION INCLUDER
07/14/2023 SCHEMATIC DESIGN X

REVISION
DATE DESCRIPTION

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COVER SHEET

JOB NUMBER: 2249901

DRAWN BY CHECKET

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SHEET NUMBER	SHEET NAME	
GENERAL	SHEET NAME	
A00.00	COVER SHEET	
A00.01	SHEET INDEX	
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C200	SITE PLAN GRADING PLAN	
C300 C400	UTILITY PLAN	
LANDSCAPE	OTILITITIAN	
L3-01	SITE PLAN	
ARCHITECTL		
A00.06	GENERAL NOTES	
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A00.80 A00.70	WALL PARTITION DETAILS	
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ELECTRICAL E107	LEVEL 3 SECTION A LIGHTING PLAN	
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E207	LEVEL 3 SECTION A POWER PLAN	
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E301 E304	TYPICAL UNIT LIGHTING PLAN TYPICAL UNIT POWER PLAN	
E305	TYPICAL UNIT POWER PLAN	

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A DEVELOPMENT FOR:

ISSUE
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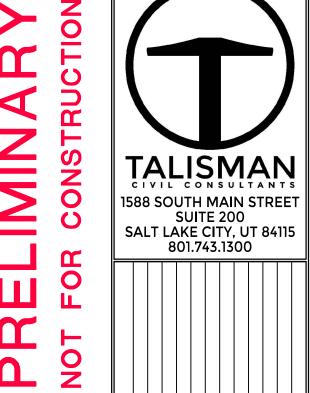
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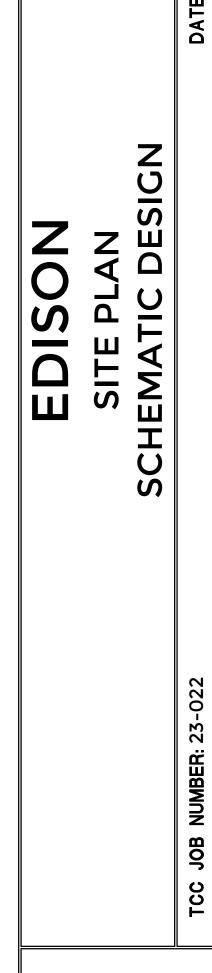
SHEET INDEX

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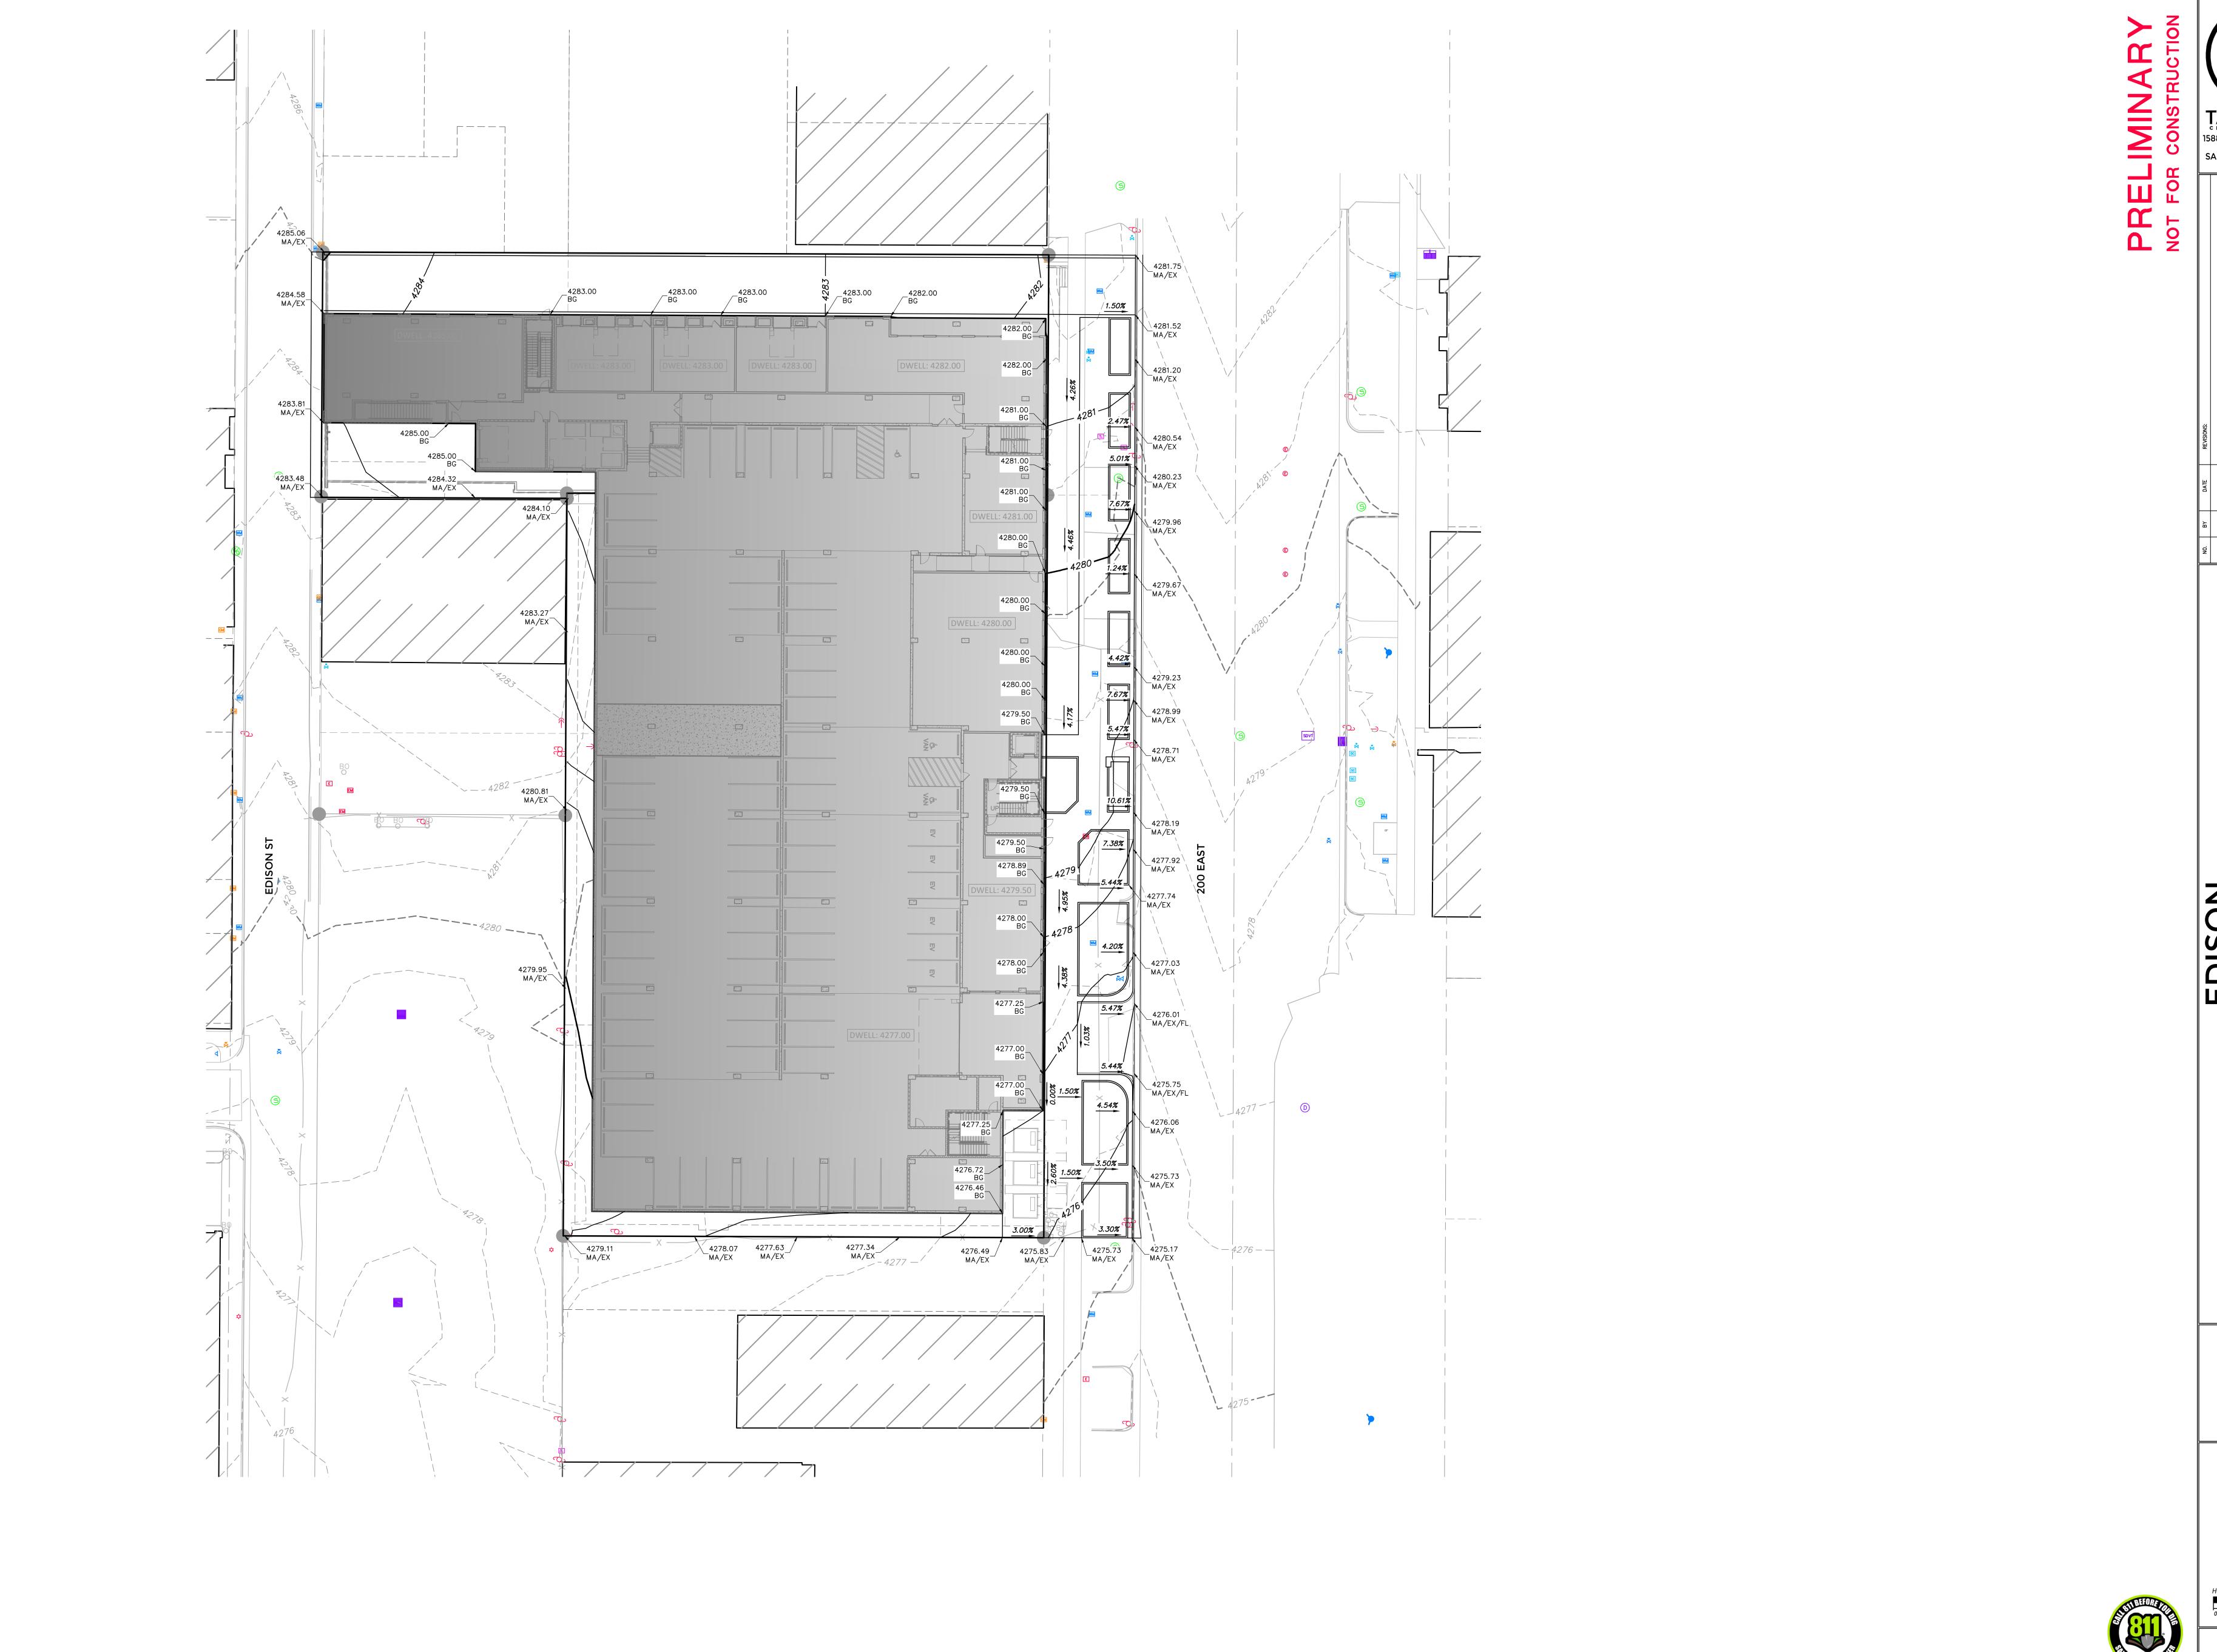
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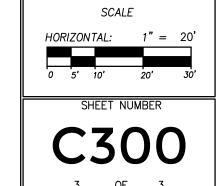



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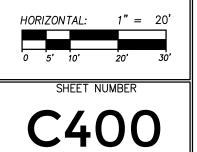
SCALE

HORIZONTAL: 1" = 20'

0 5' 10' 20' 30'





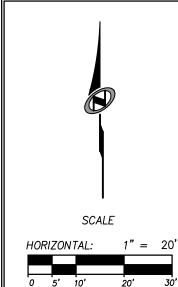



DESIGNWORKSHOP Landscape Architecture • Land Planning Urban Design • Tourism Planning

1390 Lawrence Street Suite 100 Denver, Colorado 80204 (303) 623-5186 WWW.DESIGNWORKSHOP.COM

DATE DESCRIPTION

100% SCHEMATIC DESIGN

PROJECT NUMBER: 0000

SITE PLAN

0 5' 10' ORIGINAL SCALE: 1"=10'-00"

WALL TYPE

STRUCTURAL

BUBBLE

SYMBOL

ACCESSIBILITY

GRIDLINE BUBBLE

BUILDING CONTROL-GRID BUBBLE UNIT CENTERLINE

---SHEET NUMBER

—SIMILAR DETAIL


UNIT NUMBER-

UNIT TYPE

ENLARGED PLAN MARK

GRAPHIC REPRESENTATION



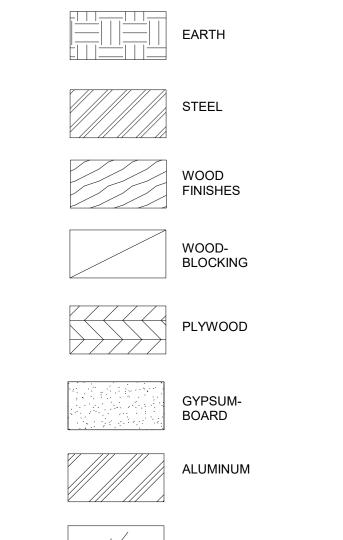

(ELEVATION)

- THE OWNER SHALL OBTAIN AND PAY FOR THE GENERAL BUILDING PERMITS AND IMPACT FEES. THESE PERMITS SHALL BE PROVIDED TO THE CONTRACTOR PRIOR TO THE START OF CONSTRUCTION.
- THE OWNER SHALL APPROVE ALL MATERIAL FINISH AND COLOR SELECTIONS, VIA CONTRACTOR SUBMITTED SHOP DRAWINGS, PRIOR TO ORDERING AND INSTALLATION FOR ANY EQUIPMENT.
- . THE OWNER SHALL COORDINATE AND SECURE AN AGREEMENT FOR ACCESS TO SITE CONSTRUCTION, STAGING AREA, AND STORAGE AREAS.

CONTRACTOR

- THE CONTRACTOR SHALL IMMEDIATELY NOTIFY THE ARCHITECT AND OWNER, IN WRITING, AND SHALL HAVE RESOLVED AND DOCUMENTED, IN WRITING, PRIOR TO CONTINUING WITH THE WORK IN QUESTION IF THERE ARE:
- A. ANY ERRORS, OMISSIONS, DISCREPANCIES, CONFLICTS, OR INCONSISTENCIES ON THESE CONTRACT DOCUMENTS.
- B. ANY VARIATION OR AMBIGUITIES BETWEEN THESE DRAWINGS AND ACTUAL SITE AND CONSTRUCTION CONDITIONS AND/OR
- C. DISCREPANCIES AND/OR UNCERTAINTIES AS TO WHAT MATERIAL OR PRODUCT IS TO BE USED.
- THE CONTRACTOR SHALL NOT RELY SOLELY ON THE ELECTRONIC VERSIONS OF THE PLANS, SPECIFICATIONS, AND DATA FILES THAT ARE OBTAINED FROM THE DESIGNERS, BUT SHALL VERIFY THE LOCATION OF PROJECT FEATURE DIMENSIONS IN ACCORDANCE WITH THE HARD
- COPIES OF THE PLANS AND SPECIFICATIONS THAT ARE SUPPLIED AS PART OF THE CONTRACT DOCUMENTS.
- A. COORDINATION OF CONSTRUCTION MEANS, METHODS, TECHNIQUES, SEQUENCES, AND PROCEDURES REQUIRED FOR SAFE EXECUTION OF EFFICIENT AND ORDERLY INSTALLATION OF EACH PART OF WORK TO BE COMPLETED.
- B. INITIATING, MAINTAINING, AND SUPERVISING ALL SAFETY PRECAUTIONS AND PROGRAMS IN CONNECTION WITH THE WORK. . THE CONTRACTOR SHALL:
- A. OBTAIN AND PAY FOR ALL OTHER PERMITS, CERTIFICATIONS AND APPROVALS REQUIRED IN CONNECTION WITH ALL WORK UNDER CONTRACT DOCUMENTS THAT ARE NOT PROVIDED BY THE OWNER.
- B. SURVEY THE PROJECT AND BECOME FAMILIAR WITH THE EXISTING CONDITIONS. VERIFY ALL SITE DIMENSIONS ON CIVIL DRAWINGS, EXISTING CONSTRUCTION GRADES AND UTILITIES ON PROJECT AT PROJECT SITE PRIOR TO BEGINNING PROJECT.
- C. EXAMINE AND BECOME FAMILIAR WITH ALL CONTRACT DOCUMENTS AND SCOPE OF WORK IN THEIR ENTIRETY. ALL ITEMS INDICATED ON ANY DRAWING SHALL BE INCLUDED AS A COMPLETE SYSTEM, UNLESS NOTED OTHERWISE.
- D. ALL COSTS SUBMITTED SHALL BE BASED ON THOROUGH KNOWLEDGE OF ALL WORK AND MATERIALS REQUIRED.
- $oxedsymbol{eta}$. INSURE THAT ALL AREAS ON THE ACCESSIBLE ROUTE THROUGHOUT THE SITE MEET THE REQUIREMENTS OF THE APPLICABLE ACCESSIBILITY CODES. COORDINATE BETWEEN CIVIL AND ARCHITECTURAL PLANS.
- F. VERIFY ALL DIMENSIONS IN THE FIELD, AND COORDINATE WORK BETWEEN ALL TRADES.
- G. PAINT ALL SURFACES WHICH REQUIRE PROTECTION FROM THE ELEMENTS WITH THE APPROPRIATE PAINT, INCLUDING NECESSARY PRIMER
- H. SEAL WITH THE APPROPRIATE TYPE OF SEALANT, AND FLASH AT ALL LOCATIONS NECESSARY TO PREVENT PENETRATION OF MOISTURE AT TRANSITIONS OF DISSIMILAR MATERIALS TO INCLUDE, BUT ARE NOT LIMITED TO:
 - CONTINUOUS 25 MIL MEMBRANE FLASHING TO ALL INSIDE AND OUTSIDE WALL CORNERS.
- FLASHING SHALL BE INSTALLED AROUND ALL WINDOW OPENINGS, ROOF OPENINGS, AND AT THE INTERSECTION OF CHIMNEYS, WOOD CONSTRUCTION, AND FRAME WALLS. SEAL AND MAKE WEATHER-TIGHT.
- b. AIR IMPERMEABLE SEALANT:

. THE CONTRACTOR SHALL BE RESPONSIBLE FOR:

- CONTINUOUS AT ALL EXTERIOR JOINTS AROUND WINDOW FRAMES, DOOR FRAMES, BETWEEN WALL CAVITIES, BETWEEN WALL AND FOUNDATION, BETWEEN WALL AND ROOF, BETWEEN WALL AND PANELS, ALL PENETRATIONS AND UTILITIES THROUGH WALLS AND ROOFS, BETWEEN ALL DISSIMILAR MATERIALS, AND ALL OTHER OPENINGS IN BUILDING ENVELOPE.
- PLUMBING & WIRING PENETRATIONS IN ENVELOPE.
- SOLE PLATES AT EXTERIOR SLAB ON GRADE
- c. WEATHERSTRIP:
- CONTINUOUS AT ALL EXTERIOR DOORS & WINDOWS
- CONTINUOUS AT ALL ATTIC ACCESSES IN CONDITIONED AREAS.
- CONTINUOUS AT INTERIOR DOOR OPENINGS INTO UNTREATED SPACE.
- d. ALL EXTERIOR WORK SHALL BE INSTALLED IN WEATHER TIGHT MANNER AS REQUIRED
- EMPLOY, AS REQUIRED BY GOVERNING AUTHORITIES, AN APPROVED TESTING LABORATORY TO MAKE ALL TESTS FOR CONCRETE, SOIL COMPACTION AND WELDING TO INSURE COMPLIANCE WITH PLANS, STANDARDS AND CODES. REFER TO CONCRETE SPECIFICATION FOR FREQUENCY OF TESTING REQUIRED. THESE COSTS SHALL BE INCLUDED IN THE CONTRACT. J. FIELD VERIFY ALL ROUGH OPENINGS.
- K. FULLY GUARANTEE THE WORK AND EQUIPMENT FOR ONE (1) YEAR FROM THE DATE OF FINAL PAYMENT AND ACCEPTANCE FROM ALL SUBCONTRACTORS AND MATERIAL SUPPLIERS.
- REMOVE RUBBISH FROM PREMISES AS OFTEN AS NECESSARY OR AS DIRECTED. ALL WORK AND EQUIPMENT SHALL BE CLEANED TO THE SATISFACTION OF THE OWNER BEFORE TURNING SAME OVER TO THE OWNER.
- M. INSPECT, REPAIR AND PREPARE FLOORS AS REQUIRED TO PROVIDE A SATISFACTORY SUB-FLOOR FOR FLOOR FINISH MATERIALS. SATISFACTORY SUB-FLOOR IS DEFINED AS A SURFACE THAT IS FREE FROM CRACKS, HOLES, RIDGES, COATINGS, OR DEFECTS THAT WOULD PREVENT ADHESIVE BOND OR IMPAIR PERFORMANCE OR APPEARANCE OF FINISHED MATERIALS.
- N. UPON COMPLETION OF THE WORK, REMOVE ALL TOOLS, EQUIPMENT, TEMPORARY PROTECTION, AND EXCESS MATERIALS FROM THE SITE. CLEAN / POLISH ALL HARDWARE AND FIXTURES. CLEAN / REMOVE ALL PAINT DRIPS / SPLATTERS AND STAINS. REMOVE ALL APPLIANCE PROTECTIONS AND LEAVE INTERIOR AREAS BROOM CLEAN, FREE OF STAINS, FILM AND FOREIGN SUBSTANCES.
-). BRING TO THE ATTENTION OF THE OWNER ANY MATERIAL SUSPECTED OF BEING HAZARDOUS WHILE ENCOUNTERED DURING EXECUTION OF THE WORK. A DETERMINATION WILL BE MADE BY THE OWNER AS TO WHETHER THE CONTRACTOR SHALL PERFORM TESTS TO
- DETERMINE IF THE MATERIAL IS HAZARDOUS.
- . THE CONTRACTOR SHALL PROVIDE AND INSTALL:
- A. ALL NECESSARY FLASHING INCLUDING (BUT NOT LIMITED TO) THROUGH FLASHING, STEP FLASHING, COUNTER FLASHING, CAP FLASHING, BASE FLASHING, AND FLEXIBLE FLASHING, WHERE NECESSARY, TO ENSURE A WATER TIGHT BUILDING.
- B. CONTINUOUS METAL CORNER BEADS AT ALL GYPSUM BOARD EXTERIOR CORNERS FROM FLOOR TO CEILING.
- C. CONTINUOUS METAL 'L' BEADS AT ALL EXPOSED GYPSUM BOARD EDGES FROM FLOOR TO CEILING.
- D. ALL LOCKING DEVICES, SECURITY DEVICES, AND GLASS IN ACCORDANCE WITH FEDERAL, STATE, AND LOCAL LAWS, REGULATIONS AND
- E. AN INSULATION AND VAPOR BARRIER THAT IS CONTINUOUS AT WALLS, CEILINGS, AND FLOOR SURFACES AT ALL OCCUPIED SPACES EXPOSED TO NON-TEMPERED AREAS.
- 3. THE CONTRACTOR SHALL PROTECT:
- A. MATERIALS WHICH ARE SENSITIVE TO DETERIORATION.
- B. THE REQUIRED PROTECTION OVER SHEAR WALLS AT ALL RATED WALLS AS APPROVED BY THE BUILDING OFFICIAL.
- C. ALL EXISTING TREES, AS NOTED TO REMAIN ON CIVIL PLANS, SHALL BE PROTECTED FROM DAMAGE DURING CONSTRUCTION BY BOXING OR
- OTHER OWNER APPROVED MEANS. D. ALL EXISTING WORK, UTILITIES, CONDUIT, PIPING, EQUIPMENT, AND/OR ADJACENT AREAS NOT SHOWN TO BE ALTERED OR REMOVED FROM DAMAGE DURING EXECUTION OF THE WORK. THE CONTRACTOR SHALL BEAR THE TOTAL EXPENSE FOR, AND SHALL REPAIR TO EXISTING

CONDITIONS, DAMAGE TO EXISTING CONSTRUCTION, EQUIPMENT, OR IMPROVEMENTS NOT INDICATED IN THE DRAWINGS SPECIFICATIONS

- TO RECEIVE ALTERATIONS, ADDITIONS, OR REMOVAL. EXISTING SURFACE STREET AND SURFACE PARKING AREAS IN A CLEAN CONDITION AND PROVIDE ADEQUATE MEANS TO CLEAN TRUCKS AND OTHER EQUIPMENT.
- THE CONTRACTOR SHALL PROVIDE FULL SCALE, WOOD FRAMED MOCK-UP WITH ACCURATE DETAILS OF CONSTRUCTION. THE APPROXIMATE SIZE SHALL BE: 20' LONG X 10' HIGH.
- A. MOCK UP SHALL INCLUDE: 1 DOOR, 2 WINDOWS, CEMENTITIOUS PANEL, BRICK, METAL PANEL, METAL RAILING, ROOF MATERIAL.
- B. THE LOCATION OF THE MOCK-UP ON THE SITE TO BE APPROVED BY OWNER AND CONTRACTOR.

CONCRETE MASONRY

CONTINUOUS

INSULATION-

BATTS

RIGID

- THERE SHALL BE NO DEVIATION FROM SPECIFICATIONS WITHOUT THE WRITTEN APPROVAL OF THE OWNER, ARCHITECT, AND/OR ENGINEER QUANTITIES INDICATED ON THE PLANS ARE PROVIDED FOR THE BENEFIT OF THE CONTRACTOR, BUT SHOULD NOT BE ASSUMED TO ALWAYS BE CORRECT. IN THE EVENT OF DISCREPANCY, THE PLAN TAKES PRECEDENCE OVER THE QUANTITY INDICATED. THE CONTRACTOR SHALL BE RESPONSIBLE FOR HIS OWN QUANTITY CALCULATIONS AND THE LIABILITY PERTAINING TO THOSE QUANTITIES AND ANY OTHER RELATED CONTRACT DOCUMENTS AND/OR PRICE QUOTATIONS
- B. "TYPICAL" MEANS THE REFERENCED DETAIL SHALL APPLY FOR ALL SIMILAR CONDITIONS UNLESS OTHERWISE NOTED.
- ALL MATERIALS SHALL BE NEW AND SHALL BE INSTALLED IN STRICT CONFORMANCE WITH MANUFACTURER'S INSTRUCTIONS AND/OR RECOMMENDATIONS.
- ROOFING SHALL BE CLASS B OR BETTER, INSTALL PER MANUFACTURER'S RECOMMENDATIONS.
- INSULATE ALL EXTERIOR WALLS & CONDITIONED SPACES W/ KRAFT FACED FIBERGLASS, UNLESS NOTED OTHERWISE, INSULATION. FRICTION
- FIT IS NOT ACCEPTABLE TO MEET REQUIRED ENERGY EFFICIENCY STANDARD.
- FIELD MODIFICATION TO WORK IN PLACE MUST COMPLY WITH THE CUTTING AND PATCHING REQUIREMENTS.
- 8. GYPSUM WALL BOARD SHALL BE:
- A. INSTALLED IN CONFORMANCE WITH THE GYPSUM ASSOCIATION'S RECOMMENDED PRACTICES FOR THICKNESS, NAILING, TAPING, AND STUD
- B. 5/8" TYPE "X" MADE IN USA. WITH MATERIAL SOURCE IN THE U.S.A.
- C. WATER-RESISTANT GYPSUM BOARD AT KITCHEN/TOILET BACKSPLASHES, AND LAUNDRY WET WALLS.
- FILL ALL CONTROL JOINTS WITH TRAFFIC SEALANT AND EXPANSION JOINTS WITH EXPANSION JOINT SYSTEM IN PARKING DECK
- 0. SIZE AND LOCATION OF ALL FLOOR OPENINGS TO BE VERIFIED WITH TRADE AFFECTED BEFORE WORK. PATCH AND SEAL ALL PENETRATIONS IN FLOOR TO COMPLY WITH APPLICABLE BUILDING AND/ OR FIRE CODES.
- I. MAXIMUM FLAME SPREAD RATING ON ALL INTERIOR FINISH MATERIALS SHALL NOT BE GREATER THAN THE REQUIREMENTS SPECIFIED IN IBC &

STRUCTURAL / FRAMING

- . DIMENSIONS:
- A. ALL DIMENSIONS ON PLANS ARE TO FACE OF STRUCTURE/STUD UNLESS OTHERWISE NOTED.
- B. ALL ANGLED WALLS ARE 45 DEGREES UNLESS NOTED OTHERWISE C. DOOR LOCATIONS NOT DIMENSIONED SHALL BE LOCATED AT MIDPOINT OF WALL OR 4" CLEAR OF ROOM, FROM ADJACENT WALL CORNER
- TYPICAL IF CLEARANCE ALLOWS.
- D. DOORS AND WINDOWS ARE DIMENSIONED TO THE CENTERLINE OF THE ELEMENT U.N.O.
- STRUCTURAL AND FIRE RESISTIVE INTEGRITY IS TO BE MAINTAINED AT ALL PENETRATIONS IN ACCORDANCE WITH THE REQUIREMENTS OF GOVERNING CODES AND AUTHORITIES.
- . SEE STRUCTURAL DRAWINGS FOR SHEAR WALL & NAILING PATTERN TABLE FOR GYPSUM WALL BOARD.
- WIND BRACE WALLS PER STRUCTURAL DRAWINGS AND PER BUILDING-CODE.
- FLOOR TOLERANCE: IN LAYING OUT AND DETAILING THE WORK TO BE COMPLETED CONSIDERATION SHALL BE GIVEN TO VARIATIONS IN THE FLOOR LEVEL RESULTING FROM CONSTRUCTION QUALITY AND LIVE AND DEAD LOADS IMPOSED ON THE STRUCTURE. FIELD VERIFICATION SHALL BE MADE OF CONDITIONS TO VERIFY CONSTRUCTION TOLERANCES.
- ALIGNMENT OF DOOR HEADS AND OTHER HORIZONTAL ELEMENTS SHALL BE MAINTAINED AT A CONSTANT LEVEL AND SHALL NOT FOLLOW VARIATIONS IN FLOOR PLANE.
- ALL WOOD SILLS IN CONTACT WITH CONCRETE TO BE PRESSURE TREATED AND HAVE A CONTINUOUS SILL SEALER. PROVIDE TERMITE SHIELDS AT CONCEALED UNDER FLOOR SPACES.
- . ALL CHIMNEYS SHALL TERMINATE 2'-0" MINIMUM HEIGHT ABOVE A POINT MEASURED 10'-0 HORIZONTALLY FROM THE NEAREST BUILDING OR
- 9. LUMBER / WALLS:
- A. COORDINATE LOCATION, CONSTRUCTION AND DETAIL OF LOAD BEARING WALLS BEFORE WORK B. ALL LUMBER SHALL BE GRADE MARKED.
- C. O.S.B. IS AN ACCEPTABLE SUBSTITUTE FOR PLYWOOD EXCEPT WHERE SPECIFIED BY STRUCTURAL ENGINEER.
- D. STUD WALLS ARE DIMENSIONED 3-1/2", 5-1/2", OR 7-1/4", UNLESS NOTED OTHERWISE
- E. PARTY WALLS ARE DIMENSIONED 8" (3-1/2" + 1" + 3-1/2") F. PLUMBING WALLS SHALL BE FRAMED WITH 2X6 OR 2X8 STUDS, UNLESS NOTED OTHERWISE.
- G. REFER TO UNIT PLANS FOR LOCATION OF 2X6 WALLS.
- H. REFER TO STRUCTURAL DRAWINGS FOR UNUSUAL OR SPECIAL FRAMING CONDITIONS I. WATER RESISTANT 1/2" CERAMIC TILE BACK BOARD SHALL BE INSTALL IN BOTH TUB AND SHOWER SURROUNDS, UNLESS NOTED
- J. ALL PENETRATIONS IN GYPSUM DRYWALL CONSTRUCTION SHALL BE SEALED WITH JOINT COMPOUND OR APPROVED ACOUSTICAL
- SEALANT TO PREVENT SOUND LEAKAGE.
- K. ALL CAVITY OR CONCEALED SPACES SHALL BE DRAFT STOPPED & FIRE BLOCKED. PROVIDE BLOCKING FOR ALL CABINETS, CEILING FANS,
- AND BATH ACCESSORIES. INCLUDE BLOCKING FOR GRAB BARS AT ALL LOCATIONS.
- 10. PATIOS AND BALCONIES SHALL BE SLOPED MIN. 1/4" PER 1'-0"" IN DIRECTION INDICATED OR TO OUTERMOST EDGE OF BUILDING STRUCTURE. ALL EXPOSED MATERIALS FOR BALCONIES, PATIOS, SOFFITS, OVERHANGS ETC. SHALL BE APPROVED EXTERIOR GRADE.
- 2. BALCONY AND PATIO SUPPORTS VARY ACCORDING TO THE EXTERIOR ELEVATIONS. SEE ELEVATIONS FOR LOCATION OF BRICK PIER, STONE PIER, POLY COLUMN OR RAILINGS AT BALCONIES.
- PROVIDE GALVANIZED METAL ANCHOR FOR WOOD POSTS BEARING DOWN ON CONCRETE SLABS, UNLESS NOTED OTHERWISE.
- 4. ALL CONCRETE WORK SHALL CONFORM TO ACI 301 "SPECIFICATIONS FOR STRUCTURAL CONCRETE FOR BUILDINGS" AND THAT DESIGN IS BASED ON ACI 318 "BUILDING CODE REQUIREMENTS FOR REINFORCED CONCRETE" AND ACI 318.1. "CONCRETE TEST REPORTS" WILL BE
- AVAILABLE ON JOB SITE IN CONSTRUCTION TRAILER. 15. ALL FRAMING TO BE IN CONFORMANCE WITH THE NATIONAL FOREST PRODUCTS "MANUAL FOR HOUSE FRAMING."
- 6. FIREBLOCKING SHALL BE PROVIDED TO FORM EFFECTIVE FIRE BARRIERS BETWEEN STORIES AND BETWEEN A STORY AND ROOF SPACE. WHERE FIREBLOCKS ARE WOOD, THEY SHALL NOT BE LESS THAN A NOMINAL TWO INCHES IN THICKNESS. FIRESTOPS SHALL BE LOCATED IN EXTERIOR AND INTERIOR WALLS, PARTITIONS AT CEILING AND FLOOR LEVELS.
- MECHANICAL, ELECTRICAL, AND PLUMBING

OTHERWISE.

- . ALL PLUMBING CHASES ARE TO EXTEND TO THE UNDERSIDE OF STRUCTURE ABOVE, UNLESS NOTED OTHERWISE.
- WHERE ELECTRICAL, MECHANICAL, AND/OR OTHER WALL MOUNTED DEVICES OCCUR AT THE SAME LOCATION BUT DIFFERENT HEIGHTS, THEY SHALL BE CENTERED ABOVE EACH OTHER.
- WATER SERVICE SHALL NOT BE PLACED IN CONCEALED SPACES OUTSIDE OF THE CONDITIONED BUILDING ENVELOPE (BREEZEWAY OR PATIO FLOOR SPACES OR ATTICS).
- . PENETRATIONS AND FIXTURES TO ALIGN VERTICALLY FROM FLOOR TO FLOOR.
- PROVIDE SUPPORT/REINFORCEMENT TO ACCOMMODATE WALL MOUNTED EQUIPMENT INCLUDING SUPPORT OF FUTURE GRAB BARS IN ALL BATHROOMS AS REQUIRED BY ADA AND/OR FAIR HOUSING ACT.
- COORDINATE LOCATION AND/OR ELEVATION OF FLOOR DRAINS, REGISTERS, GRILLES, LOUVERS CONVECTORS, PANELS, ETC. WITH MECHANICAL AND ELECTRICAL CONTRACTORS
- FIRE PROTECTION SYSTEM SHALL BE DESIGNED BY THE FIRE PROTECTION CONTRACTOR.
- A. PROVIDE COMPLETE DESIGN AND SHOP DRAWINGS FOR FIRE SPRINKLER SYSTEM.
- B. PROVIDE FOR ALL STATE AND LOCAL SUBMITTALS AND/OR APPROVALS FOR QUICK RESPONSE SPRINKLER SYSTEM.
- C. ALL SPRINKLER PIPING SUBJECT TO FREEZING SHALL BE DRY-TYPE SYSTEMS WHERE PERMITTED.
- VENT DRYERS TO OUTSIDE. SEE MECHANICAL DRAWINGS.
- ALL OUTLETS @ KITCHEN SINK & BATH LAVATORY COUNTERS TO BE GFCI. 0. MECHANICAL DUCTWORK TO BE SEPARATED FROM ELECTRICAL PANELS
- 11. SMOKE DETECTORS SHALL NOT BE PLACED IN FRONT OF EXHAUST GRILLS
- 2. SMOKE DETECTORS SHALL BE CONTINUOUSLY BE POWERED BY BUILDING ELECTRICAL SYSTEM AND INSTALLED IN ACCORDANCE WITH NFPA AND IBC W/ BATTERY BACK UP.

- . THE CONTRACTOR SHALL MEET:
- A. ALL REQUIREMENTS OF THE BUILDING CODE AND FEDERAL, STATE, AND LOCAL LAWS, REGULATIONS, AND REQUIREMENTS, EVEN IF IT REQUIRES LABOR AND/OR MATERIALS NOT INDICATED ON PLANS.
- B. ALL LAWS, ORDINANCES, RULES AND REGULATIONS OF ALL AUTHORITIES HAVING JURISDICTION.
- C. ALL WORK PERFORMED UNDER, AND IN CONNECTION WITH THESE DRAWINGS SHALL BE IN STRICT COMPLIANCE WITH THE LATEST O.S.H.A. SAFETY AND HEALTH STANDARDS.
- D. OPERATING FEATURES SHALL COMPLY WITH IBC AND NFPA WHILE BUILDING IS UNDER CONSTRUCTION.
- E. ALL INSTALLED SIGNAGE TO COMPLY WITH 2010 ADA SECTIONS 216 AND 703.
- PROVIDE ACCESS PANELS AS MANDATED BY LOCAL GOVERNING AUTHORITIES PROJECT SITE, BUILDINGS AND UNITS SHALL MEET OR EXCEED THE FAIR HOUSING ACCESSIBILITY GUIDELINES AS PUBLISHED IN THE FEDERAL
- REGISTER VOLUME 56, NUMBER 44, ON MARCH 6, 1991. THE FOLLOWING ARE ADDRESSED IN MEETING THE GUIDELINES: A. ACCESSIBLE ENTRANCES/ ACCESSIBLE ROUTES.
- B. PUBLIC AND COMMON AREAS MEETING ADA/ANSI AND ADA TITLE II REQUIREMENTS
- C. USABLE DOORS D. ACCESSIBLE ROUTE INTO AND THROUGH THE COVERED UNIT
- E. LIGHT SWITCHES, ELECTRICAL OUTLETS, THERMOSTAT, AND ENVIRONMENTAL LOCATIONS
- F. GRAB BAR REINFORCEMENT LOCATIONS.
- G. USABLE BATHROOMS AND KITCHENS.
- . ALL HANDICAPPED RAMPS SHALL BE BROOM FINISHED PERPENDICULAR TO SLOPE. SLOPE RAMPS AT 1:12 (MAX).
- NO FRAMING AT ANY TIME IS TO BE CONCEALED PRIOR TO INSPECTION BY GOVERNING AUTHORITIES
- . WHILE BUILDING IS UNDER CONSTRUCTION, OPERATING FEATURES SHALL COMPLY WITH IBC CHAPTER 33 & NFPA 241.

- ALL SITEWORK AND LANDSCAPING SHALL BE ESTABLISHED AND DESIGNED BY OTHERS (THAN THE ARCHITECT)
- ALL WORK AND EQUIPMENT SHALL BE CLEANED TO THE SATISFACTION OF THE OWNER BEFORE TURNING SAME OVER TO OWNER.
- STORE MATERIALS IN SPACES DESIGNATED BY OWNER. REFER TO CIVIL DRAWINGS FOR DIMENSIONAL CONTROL PLAN AND GRADING, FIRE HYDRANT LOCATIONS, AND CURB CUTS.
- REFER TO LANDSCAPING DRAWINGS FOR LOCATION OF SIDEWALKS AND DETAILS. REFER TO CIVIL AND LANDSCAPE DRAWINGS FOR SITE DETAILS.
- REFER TO ELECTRICAL AND LANDSCAPING DRAWINGS FOR EXTERIOR BUILDING LIGHTING AND TRANSFORMER LOCATIONS.

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A DEVELOPMENT FOR:


ISSUE DATE DESCRIPTION 07/14/2023 SCHEMATIC DESIGN

DESCRIPTION

SHEET NAME: **GENERAL NOTES**

JOB NUMBER: 2249901


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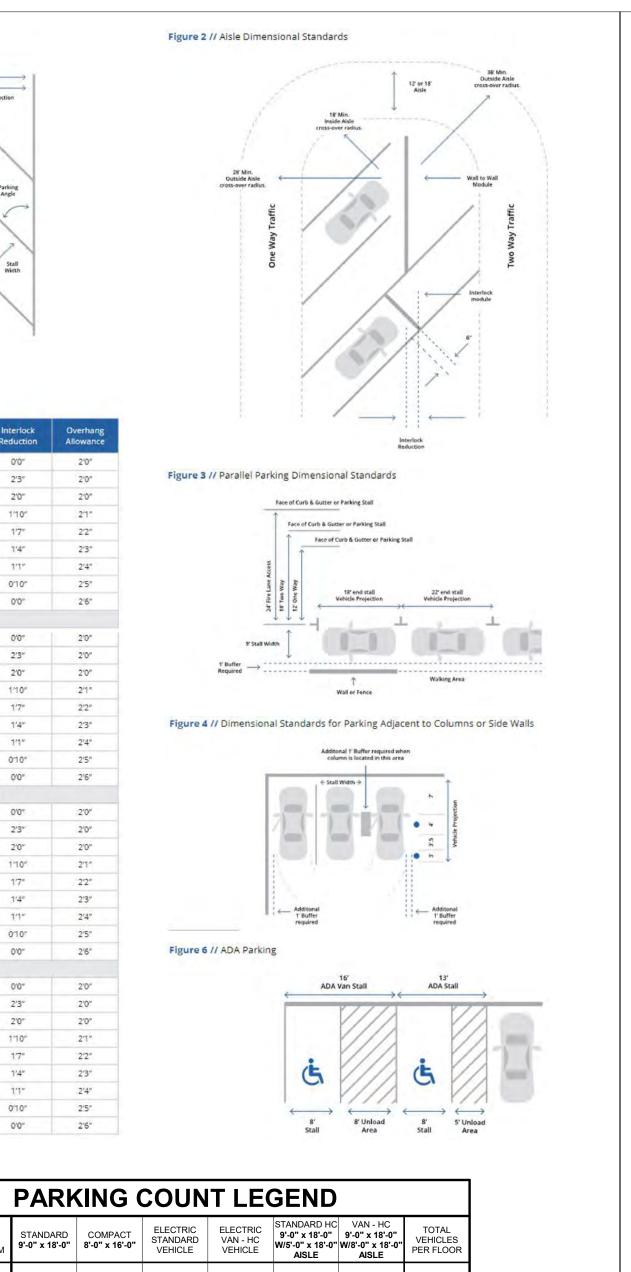
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A DEVELOPMENT FOR:

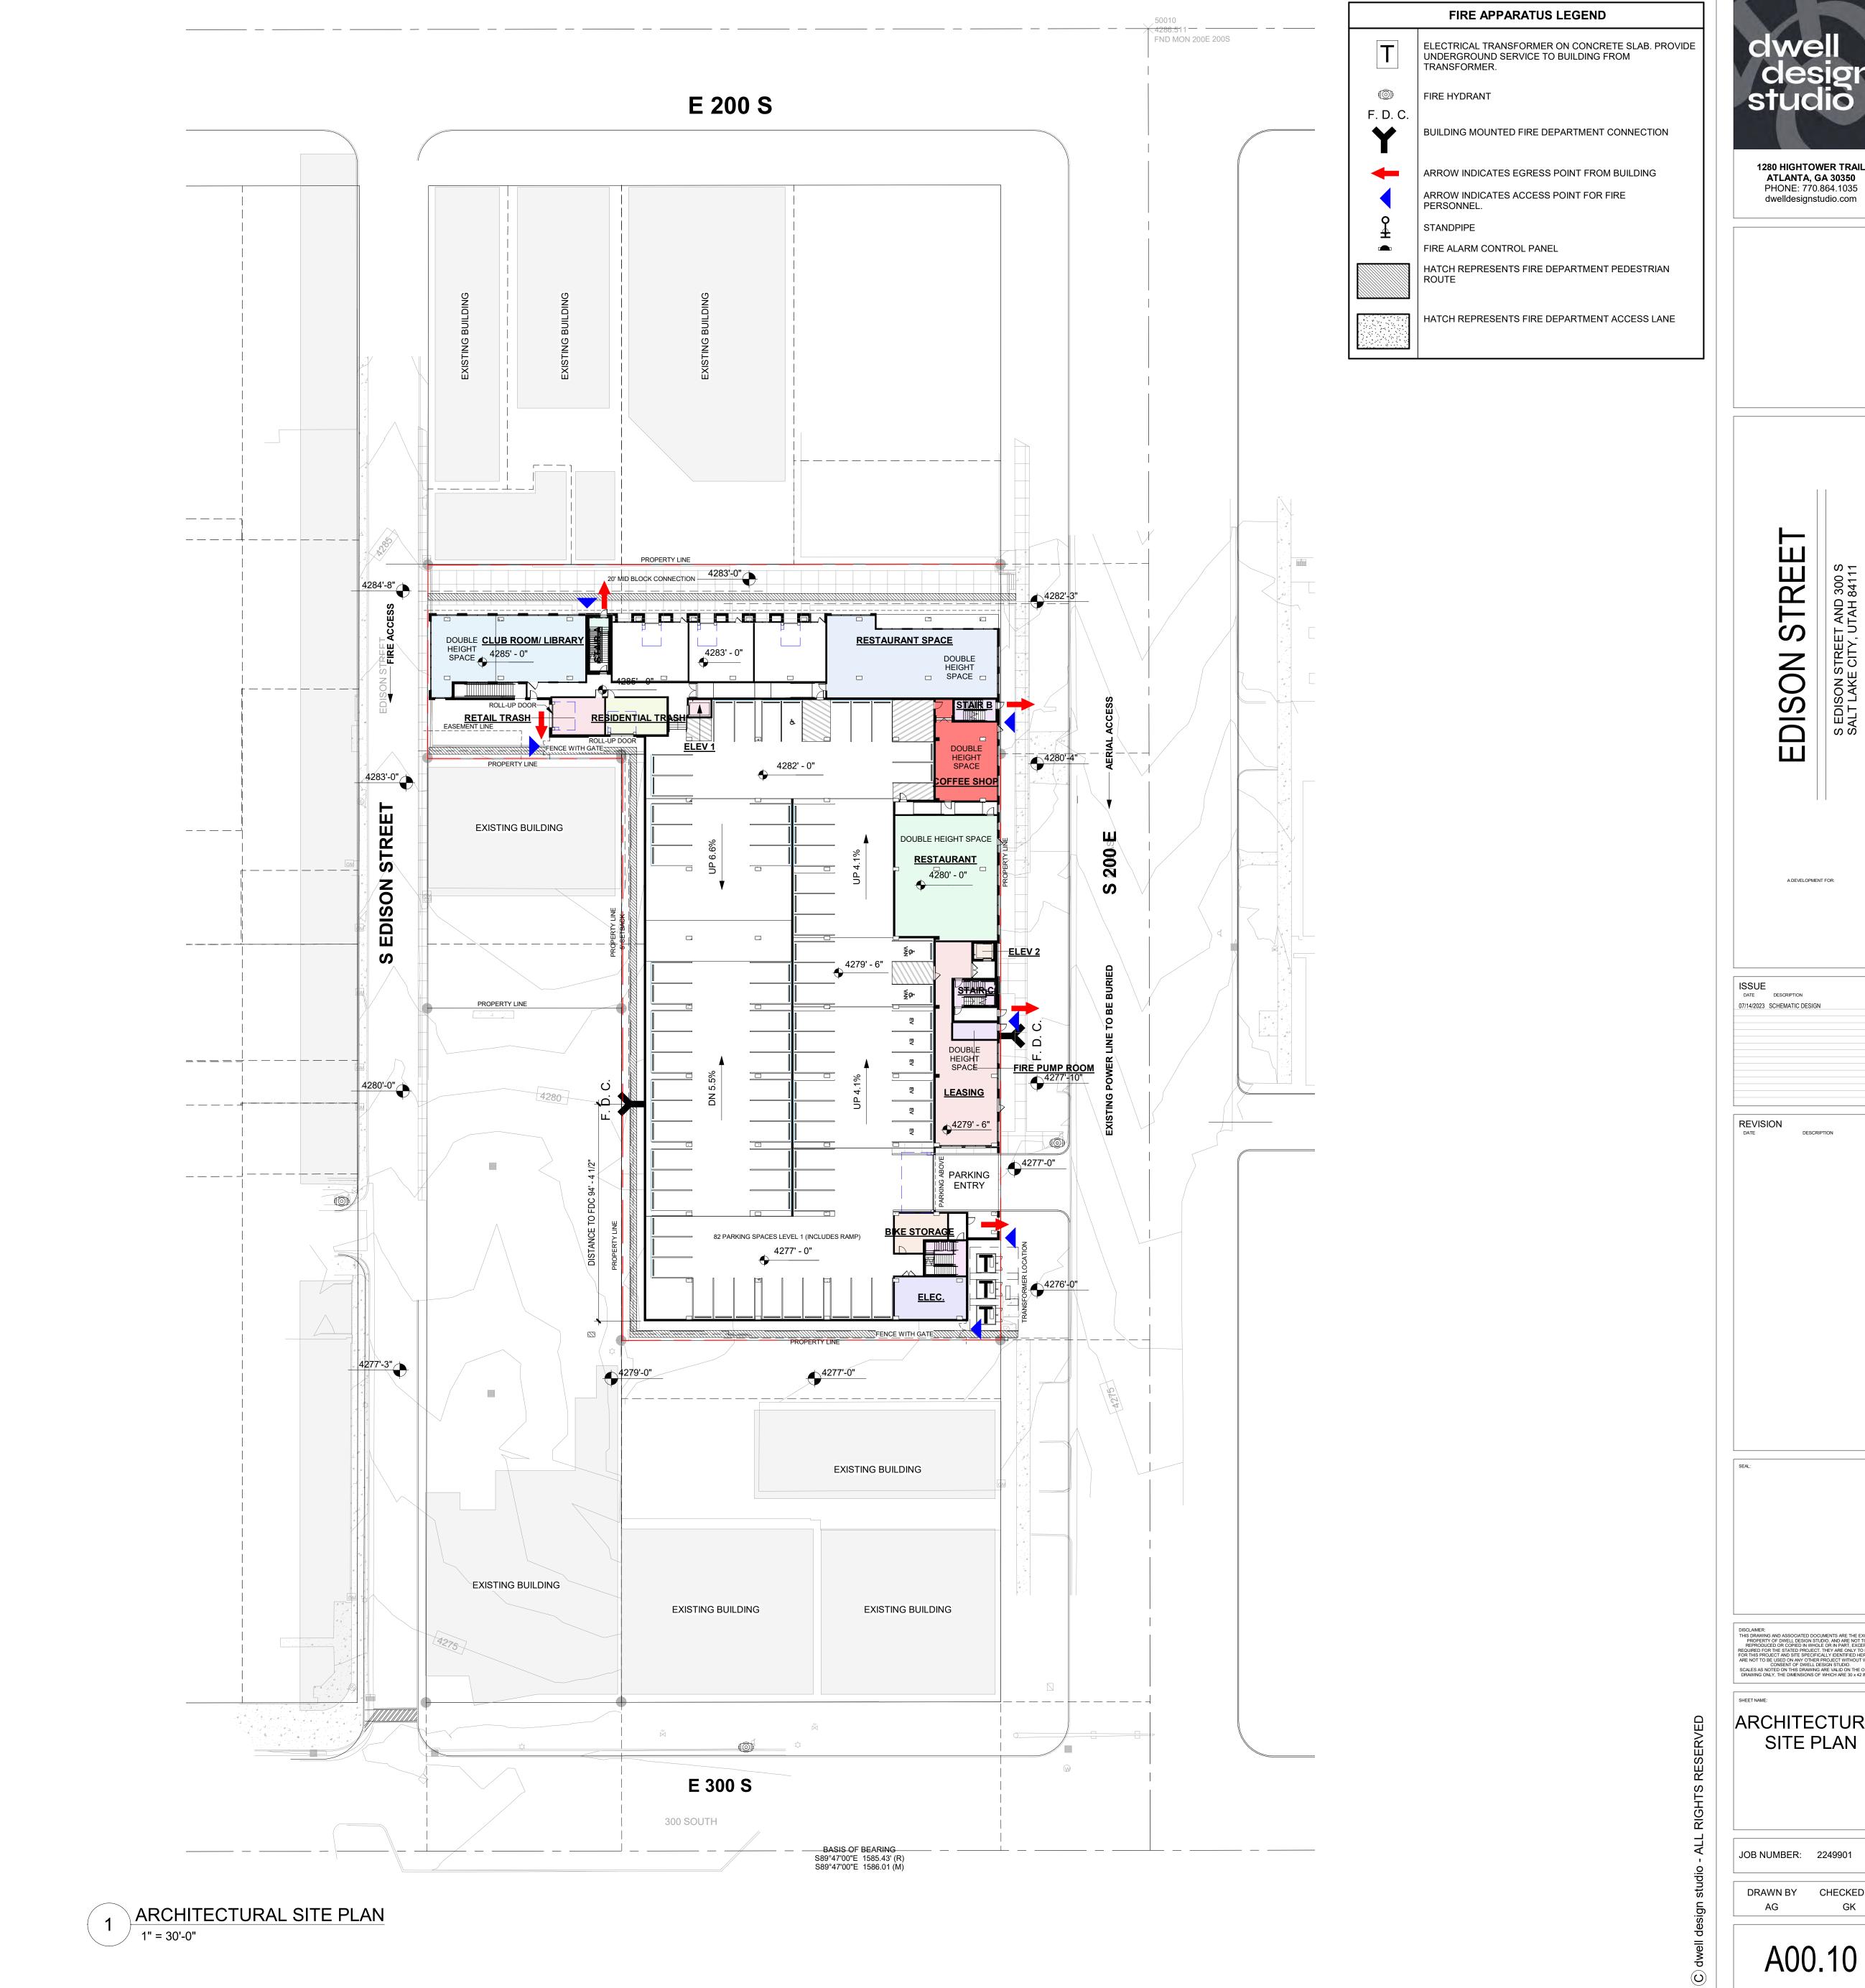ARCHITECTURAL SITE PLAN



6 SITE DATA PLAN - LEVEL 7
1/64" = 1'-0"

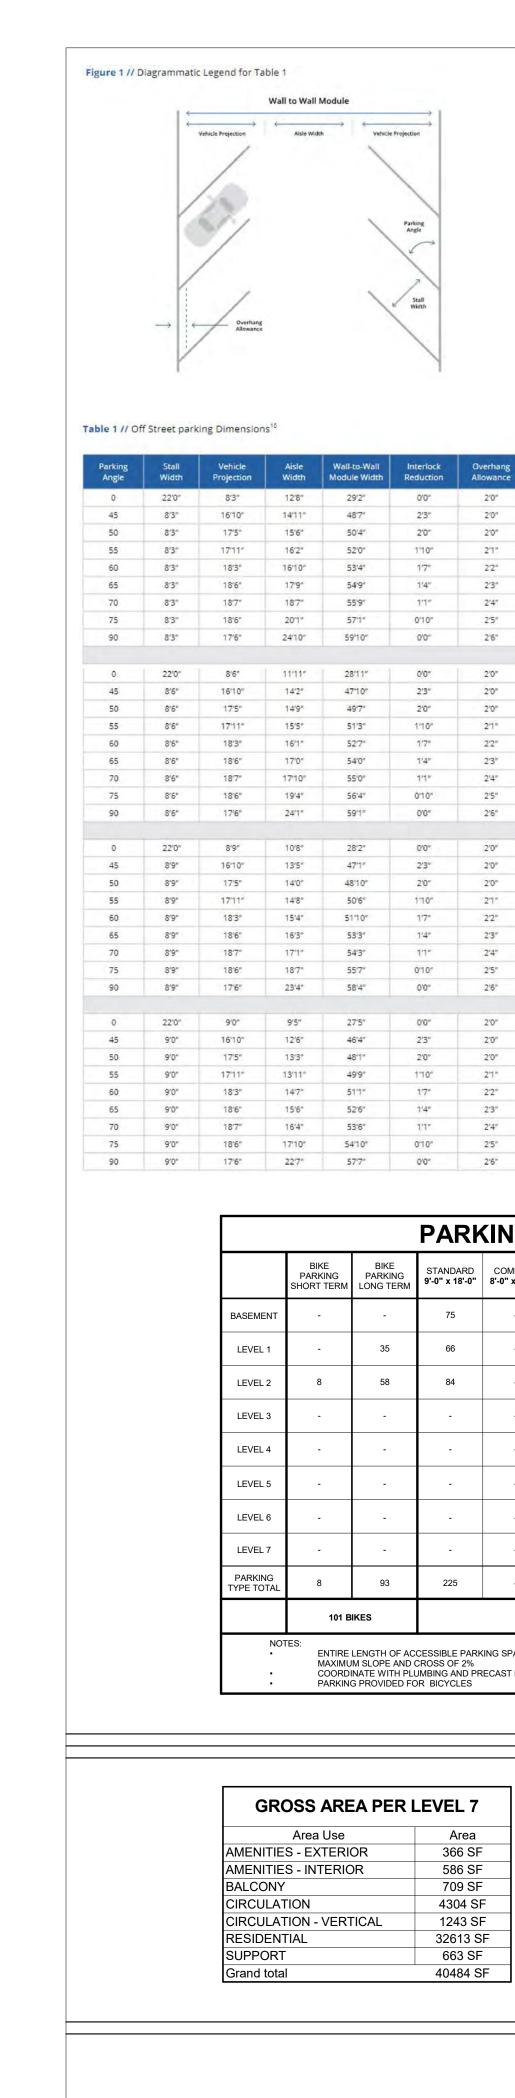

Level	Area	BUILDING	Area Use	Area
SEMENT LEVEL	37261 SF	BASEMENT LE	EVEL	
EL 1	49436 SF	BLDG 1000	CIRCULATION	340 SF
VEL 2	41253 SF	BLDG 1000	CIRCULATION - VERTICAL	561 SF
/EL 3	50121 SF	BLDG 1000	RETAIL	1783 SF
VEL 4	40483 SF			2684 SF
VEL 5 VEL 6	40500 SF 40500 SF	LEVEL 1 BLDG 1000	AMENITIES - INTERIOR	3732 SF
VEL 6 VEL 7	40500 SF 40484 SF	BLDG 1000 BLDG 1000	CIRCULATION	3732 SF 1173 SF
and total	340039 SF	BLDG 1000 BLDG 1000	CIRCULATION - VERTICAL	1260 SF
and total	040000 01	BLDG 1000	RETAIL	8863 SF
		BLDG 1000	SUPPORT	1614 SF
				16642 SF
		LEVEL 2		
		BLDG 1000	CIRCULATION	1297 SF
		BLDG 1000	CIRCULATION - VERTICAL	900 SF
		BLDG 1000	RETAIL	3636 SF
		BLDG 1000	SUPPORT	848 SF
		ן דערן פ		6680 SF
		LEVEL 3 BLDG 1000	AMENITIES - EXTERIOR	9567 SF
		BLDG 1000 BLDG 1000	AMENITIES - EXTERIOR AMENITIES - INTERIOR	4315 SF
		BLDG 1000	BALCONY	718 SF
		BLDG 1000	CIRCULATION	4648 SF
		BLDG 1000	CIRCULATION - VERTICAL	1264 SF
		BLDG 1000	RESIDENTIAL	28946 SF
		BLDG 1000	SUPPORT	663 SF
				50121 SF
		LEVEL 4	DALOCAN/	700 0-
		BLDG 1000	BALCONY	709 SF
		BLDG 1000 BLDG 1000	CIRCULATION CIRCULATION - VERTICAL	4318 SF 1244 SF
		BLDG 1000 BLDG 1000	RESIDENTIAL	33550 SF
		BLDG 1000 BLDG 1000	SUPPORT	663 SF
		BEBG 1000	COLL CICL	40483 SF
		LEVEL 5		10 100 01
		BLDG 1000	BALCONY	354 SF
		BLDG 1000	CIRCULATION	4318 SF
		BLDG 1000	CIRCULATION - VERTICAL	1260 SF
		BLDG 1000	RESIDENTIAL	33905 SF
		BLDG 1000	SUPPORT	663 SF
				40500 SF
		LEVEL 6	DALOONIV	054.05
		BLDG 1000	BALCONY	354 SF
		BLDG 1000 BLDG 1000	CIRCULATION CIRCULATION - VERTICAL	4318 SF 1260 SF
		BLDG 1000 BLDG 1000	RESIDENTIAL	33905 SF
		BLDG 1000	SUPPORT	663 SF
			1	40500 SF
		LEVEL 7		
		BLDG 1000	AMENITIES - EXTERIOR	366 SF
		BLDG 1000	AMENITIES - INTERIOR	586 SF
		BLDG 1000	BALCONY	709 SF
		BLDG 1000	CIRCULATION	4304 SF
		BLDG 1000	CIRCULATION - VERTICAL	1243 SF
		BLDG 1000	RESIDENTIAL	32613 SF
		BLDG 1000	SUPPORT	663 SF
		Grand total		40484 SF 238097 S
		Grand total		∠36U9/ S
		GDOSS	PARKING AREAS PER	1 EV/E1
		BUILDING	Area Use	Area
		BASEMENT LE	EVEL	
		PARKING	AMENITIES - INTERIOR	606 SF
		PARKING	CIRCULATION - VERTICAL	379 SF
		PARKING	PARKING	32026 SF

PARKING

PARKING

PARKING

PARKING

PARKING

PARKING

PARKING

PARKING

Grand total

SUPPORT

AMENITIES - INTERIOR

AMENITIES - INTERIOR

CIRCULATION - VERTICAL 380 SF

CIRCULATION - VERTICAL 502 SF

4 SITE DATA PLAN - LEVEL 3
1/64" = 1'-0"

CIRCULATION

PARKING

1565 SF

34576 SF

357 SF

101 SF

31955 SF

32794 SF

606 SF

33464 SF 34572 SF

101942 SF


5 SITE DATA PLAN - LEVEL 4-6
1/64" = 1'-0"

7/12/2023

J FISHER COMPANY - EDISON STREET

	UNIT MIX							_												
UNIT TYPE	DESCRIPTION	BEDS		AREA		В	1	2	3	4	5	6	7	TOTAL UNITS	TOTAL BEDS		BUILDIN			%
			HEATED*	BALCONY	GROSS**											HEATED	*	GROSS*	ķ .	
TUDIO UNITS																				
NIT S1	STUDIO	1	542	0	542 SF	0	0	0	6	6	6	6	6	30	30	16,260	SF	16,260	SF	15.23
NIT S2	STUDIO	1	632	0	632 SF	0	0	0	2	2	2	2	2	10	10	6,320	SF	6,320	SF	5.08
	TOTALS													40	40	22,580		22,580		20.30
BEDROOM UN	ITS																			
NIT A1	1 BEDROOM / 1 BATH	1	723	0	723 SF	0	0	0	11	9	9	9	9	47	47	33,981	SF	33,981	SF	23.86
NIT A2	1 BEDROOM / 1 BATH	1	789	85	874 SF	0	0	0	8	8	8	8	8	40	40	31,560	SF	34,960	SF	20.30
	TOTALS													87	87	65,541		68,941		44.16
BEDROOM DE	N UNITS																			
INIT A3	1 BEDROOM / 1 BATH + DEN	1	865 SF	0	865 SF	0	0	0	2	3	3	3	3	14	14	12,110	SF	12,110	SF	7.11
	TOTALS							·						14	14	12,110		12,110		7.11
BEDROOM UN	ITS																			
NIT B1	2 BEDROOM / 2 BATH	2	946	0	946 SF	0	0	0	0	1	1	1	0	3	6	2,838	SF	2,838	SF	1.52
NIT B2	2 BEDROOM / 2 BATH	2	1,084	0	1,084 SF	0	0	0	4	8	8	8	8	36	72	39,024	SF	39,024	SF	18.27
NIT B3	2 BEDROOM / 2 BATH	2	1,088	0	1,088 SF	0	0	0	2	2	2	0	0	6	12	6,528	SF	6,528	SF	3.05
INIT B4	2 BEDROOM / 2 BATH	2	1,164	0	1,164 SF	0	0	0	1	1	1	1	1	5	10	5,820	SF	5,820	SF	2.54
INIT B5	2 BEDROOM / 2 BATH	2	1,066	0	1,066 SF	0	0	0	1	1	1	0	0	3	6	3,198	SF	3,198	SF	1.52
INIT B6	2 BEDROOM / 2 BATH	2	1,654	0	1,654 SF	0	0	0	0	0	0	2	0	2	4	3,308	SF	3,308	SF	1.02
INIT B7	2 BEDROOM / 2 BATH	2	1,066	0	1,066 SF	0	0	0	0	0	0	1	0	1	2	1,066	SF	1,066	SF	0.51
	TOTALS												_	56	112	61,782		61,782		28.43
OTAL UNITS					,	0	0	0	37	41	41	41	37	197	253	162,013	SF	165,413	SF	100.00
														UNIT AVERAGE		82	2 SF			
]						
	STUDIO UNITS 1 BEDROOM UNITS					0	0		19	8 17	8 17	8 17	17							
							0							-						
	1 BEDROOM LINITS					0			2	3	3	3	3	_						
	2 BEDROOM UNITS					0	0	0	16	26	26	26	18							
EDS .						n	0	0	45	54	54	54	46	BED AVERAGE		64	0 SF			

2 SITE DATA PLAN - LEVEL 1
1/64" = 1'-0"

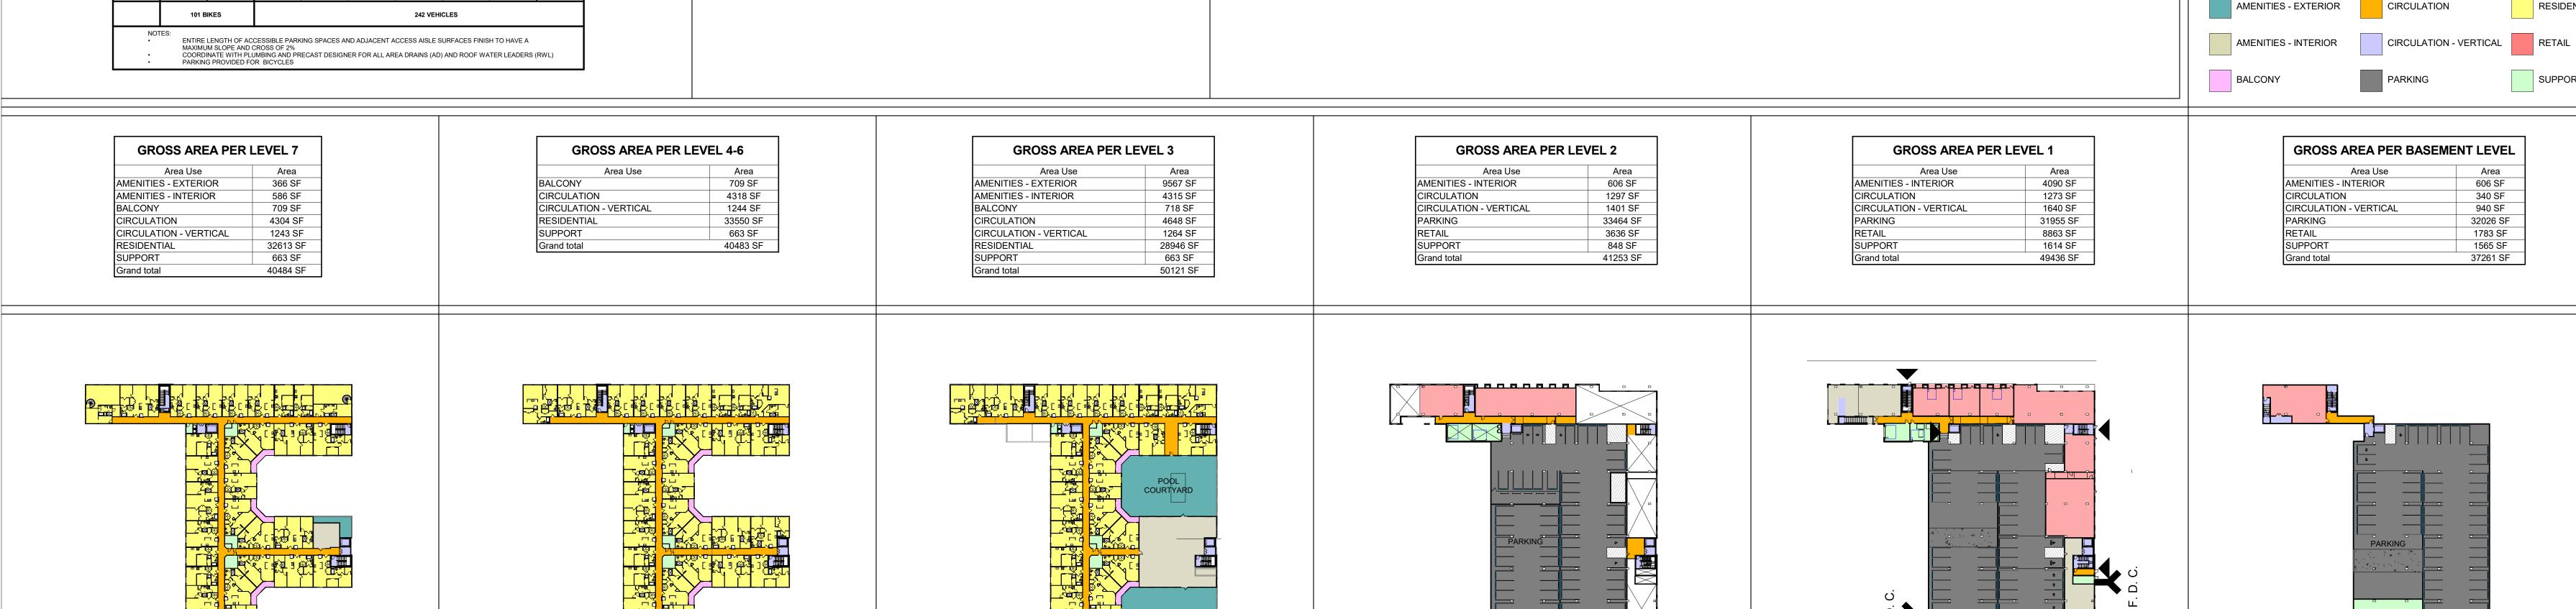

3 SITE DATA PLAN - LEVEL 2
1/64" = 1'-0"



STREE DISON

ISSUE DESCRIPTION 07/14/2023 SCHEMATIC DESIGN REVISION DESCRIPTION

RESIDENTIAL

SUPPORT

LIFE SAFETY PLAN LEGEND

1 SITE DATA PLAN - BASEMENT LEVEL
1/64" = 1'-0"

A DEVELOPMENT FOR:

SHEET NAME:

SITE DATA PLAN

JOB NUMBER: 2249901 DRAWN BY CHECKED BY

		CODE DATA						
BUILDING IDENTIFICATION :	BUILDI	ING B - FLOORS THREE THRO	DUGH SEVEN					
BUILDING OCCUPANCY CLASSIFICATION:	R-2, A							
AREA ALLOWED (PER 506.2.3): SQ.FT. INCREASE ALLOWED BY AREA MODIFICATIONS (PER 506)	360,00	0 SQ.FT.						
AREA ALLOWED PER FLOOR (PER 506.2) :	72.000	SQ.FT.						
AREA PROVIDED	50,121							
TYPE OF CONSTRUCTION :	IIIA							
BUILDING HEIGHT ALLOWANCE (PER 504.3):	85' - 0"							
BUILDING HEIGHT PROVIDED :	54' - 0"							
NUMBER OF STORIES ALLOWED (PER 504.4):	5							
NUMBER OF STORIES PROVIDED :	5							
IRE RATING :		WALLS AND PARTITIONS	OPENING PROTECTION					
FIRE WALLS (PER 706.4):		3 HOUR	3 HOUR FIRE DOOR					
SHAFT ENCLOSURES GREATER THAN 4 STORIES (PER 713.	.4):	2 HOUR	1 1/2 FIRE DOOR					
MIXED OCCUPANCY SEPARATION (PER 508.4):		1 HOUR	1 HOUR FIRE DOOR					
INTERIOR BEARING WALLS (PER 601):		1 HOUR	3/4 HOUR FIRE DOOR					
INTERIOR BEARING WALLS (PER 601):		0 HOUR	N/A					
EXT. BEARING WALLS (PER 601):		2 HOUR	1 1/2 HOUR FIRE DOOR					
EXT. NON-BEARING WALLS: GREATER THAN 30' SEPARATION	N (PER 602).	0 HOUR	N/A					
EXT. NON-BEARING WALLS: LESS THAN 30' SEPARATION (P	` ,	1 HOUR	3/4 HOUR FIRE DOOR					
CORRIDOR WALLS (PER 1020.1):	LIX 002).	1 HOUR	1/3 HOUR FIRE DOOR					
ELEVATOR SHAFT WALLS (PER 713.4):		2 HOUR	1 1/2 HOUR FIRE DOOR					
REFUSE CHUTE SHAFT WALLS AND TERMINATION ROOM (F	DED 712 12\·	2 HOUR	1 1/2 HOUR FIRE DOOR					
REFUSE ACCESS AND ROOMS (PER 713.13):	FER / 13.13).	1 HOUR	3/4 HOUR FIRE DOOR					
			N/A					
FLOOR / CEILING CONSTRUCTION (PER 601):		1 HOUR	N/A N/A					
ROOF CEILING CONSTRUCTION (PER 601): PRIMARY STRUCTURAL FRAME (PER 601):		1 HOUR 1 HOUR	N/A					
STAIRS:								
STAIR WIDTH (PER 1009.1):	MIN. R	EQUIRED: 44"	MIN. PROVIDED 48"					
ELEVATOR LOBBIES								
REQUIRED:	NO (PE	ER 3006.2 EXCEPTION 2)						
FLOOR LOCATIONS:	N/A	·						
FIRE PROTECTION SYSTEM								
SPRINKLER SYSTEM PROVIDED (PER 903.3.1.1):	NFPA	13						
STANDPIPES REQUIRED (PER 905):	YES. V	YES. WET PIPE SYSTEM WITH STANDPIPES LOCATED IN STAIRWAYS						
FIRE EXTINGUISHERS (PER 906):	MINIM	MINIMUM RATING OF 1-A:10-B:C. 75 FEET MAXIMUM TRAVEL DISTANCE.						
EXITS REQUIRED								
BUILDING EXITS (PER 1021.1):	PER FI	LOOR: 2						
HORIZONTAL EXITS (PER 1025):	SEE PI	SEE PLANS						
TRAVEL DISTANCE (PER 1017.2):	250 FE	ET						
DEAD END CORRIDOR (PER 1018.4 EXCEPTION 2):	50 FEE	ET ALLOWED						
UNITS OF EGRESS (PER 1005.1):	CORR	IDOR WIDTH = .20 PER OCCU	PANT					
	STAIR	WIDTH = .30 PER OCCUPANT						
ROOF ACCESS								
	YES							
ROOF ACCESS PROVIDED:								
	l							
ATTIC VENTILATION ATTIC VENTILATION REQUIRED (PER 1202.2):	NO. UN	NVENTED ATTIC PER 1202.3						

BUILDING IDENTIFICATION :	BUILDI	ING A - FLOORS ONE AND TW	10						
BUILDING OCCUPANCY CLASSIFICATION :	R-2, B,	R-2, B, A, S2							
AREA ALLOWED (PER 506.2.3):	UNLIM	ITED							
SQ.FT. INCREASE ALLOWED BY AREA MODIFICATIONS PER 506)	N/A								
AREA ALLOWED PER FLOOR (PER 506.2) :	UNLIM	ITED							
AREA PROVIDED	49,409								
YPE OF CONSTRUCTION :	IA								
BUILDING HEIGHT ALLOWANCE (PER 504.3):	UNLIM								
BUILDING HEIGHT PROVIDED :	29' - 0"								
NUMBER OF STORIES ALLOWED (PER 504.4):	UNLIM	IIED							
NUMBER OF STORIES PROVIDED :	2								
RE RATING :		WALLS AND PARTITIONS	OPENII	NG PROTECTION					
FIRE WALLS (PER 706.4):		2 HOUR	2 HOUI	R FIRE DOOR					
SHAFT ENCLOSURES GREATER THAN 4 STORIES (PER 71	3.4):	2 HOUR	1 1/2 FI	IRE DOOR					
MIXED OCCUPANCY SEPARATION (PER 508.4):		1 HOUR	1 HOUI	R FIRE DOOR					
INTERIOR BEARING WALLS (PER 601):		3 HOUR	3 HOUI	R FIRE DOOR					
INTERIOR NON-BEARING WALLS (PER 601):		0 HOUR	N/A						
EXT. BEARING WALLS (PER 601):		3 HOUR	1 1/2 H	OUR FIRE DOOR					
EXT. NON-BEARING WALLS: GREATER THAN 30' SEPARAT	TON (PER 602):	1 HOUR	3/4 HO	UR FIRE DOOR					
EXT. NON-BEARING WALLS: LESS THAN 30' SEPARATION ((PER 602):	0 HOUR	N/A						
CORRIDOR WALLS (PER 1020.1):		0 HOUR	N/A						
ELEVATOR SHAFT WALLS (PER 713.4):		2 HOUR	1 1/2 H	OUR FIRE DOOR					
REFUSE CHUTE SHAFT WALLS AND TERMINATION ROOM	(PER 713.13):	2 HOUR	1 1/2 H	OUR FIRE DOOR					
REFUSE ACCESS AND ROOMS (PER 713.13):		1 HOUR	3/4 HO	UR FIRE DOOR					
FLOOR / CEILING CONSTRUCTION (PER 601):		1 HOUR	N/A						
ROOF CEILING CONSTRUCTION (PER 601):		1 HOUR	N/A						
PRIMARY STRUCTURAL FRAME (PER 601):		1 HOUR	N/A						
STAIRS : STAIR WIDTH (PER 1009.1):	MINLD	EQUIRED: 44"	MINI DE	ROVIDED 44"					
STAIR WIDTH (FER 1009.1).	IVIIIV. IX	EQUINED. 44	IVIIIN. FIN	ACVIDED 44					
ELEVATOR LOBBIES									
REQUIRED:	NO (PE	ER 3006.2 EXCEPTION 2)							
FLOOR LOCATIONS:	N/A								
FIRE PROTECTION SYSTEM									
SPRINKLER SYSTEM PROVIDED (PER 903.3.1.1):	NFPA	13							
STANDPIPES REQUIRED (PER 905):	YES. V	VET PIPE SYSTEM WITH STAI	NDPIPES	LOCATED IN STAIRWAYS					
FIRE EXTINGUISHERS (PER 906):	MINIM	MINIMUM RATING OF 1-A:10-B:C. 75 FEET MAXIMUM TRAVEL DISTANCE.							
EXITS REQUIRED		1000.0							
BUILDING EXITS (PER 1021.1):		LOOR: 2							
HORIZONTAL EXITS (PER 1025):	N/A	·cT							
TRAVEL DISTANCE (PER 1017.2):	400 FE								
DEAD END CORRIDOR (PER 1018.4 EXCEPTION 2):		LOWED	IDANIT	NVA					
UNITS OF EGRESS (PER 1005.1):		IDOR WIDTH = .20 PER OCCU WIDTH = .30 PER OCCUPANT		N/A					
	3.7(
ROOF ACCESS									
ROOF ACCESS PROVIDED:	N/A								
TTIO VENTUATION									
ATTIC VENTILATION	N/A								
ATTIC VENTILATION REQUIRED (PER 1202.2):									



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SEDISON STREET AND 300 S

A DEVELOPMENT FOR:

ISSUE
DATE DESCRIPTION INCLUDED
07/114/2023 SCHEMATIC DESIGN X

REVISION DESCRI

0541


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SCALES AS NOTED ON THIS DRAWING ARE VALID ON THE ORIGINAL DRAWING ONLY, THE DIMENSIONS OF WHICH ARE 30 x 42 INCHES.

CODE DATA SHEET

JOB NUMBER: 2249901

DRAWN BY CHECKED BY
Author GK

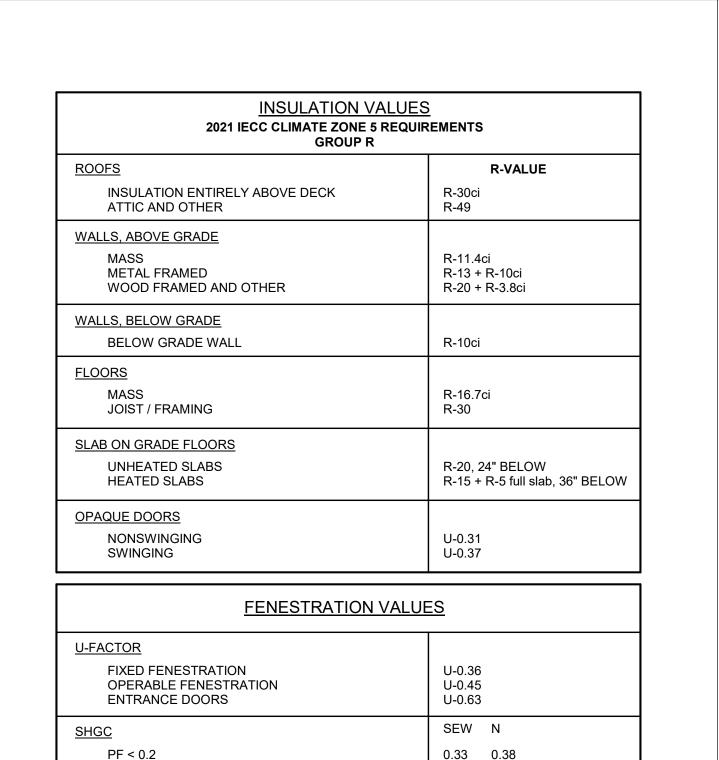


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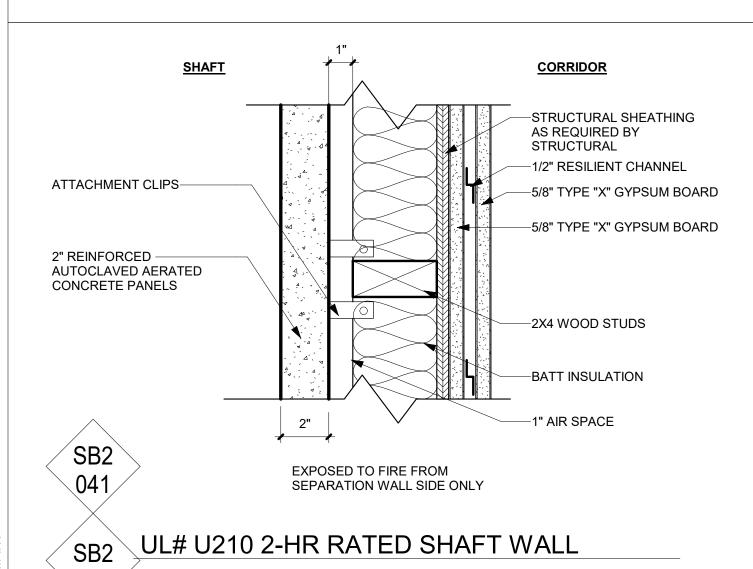
*VERIFY ALL INSULATION VALUES WITH PROVIDED COMCHECK BUILDING ENVELOPE COMPLIANCE REPORT AND PROVIDED ENERGY MODEL


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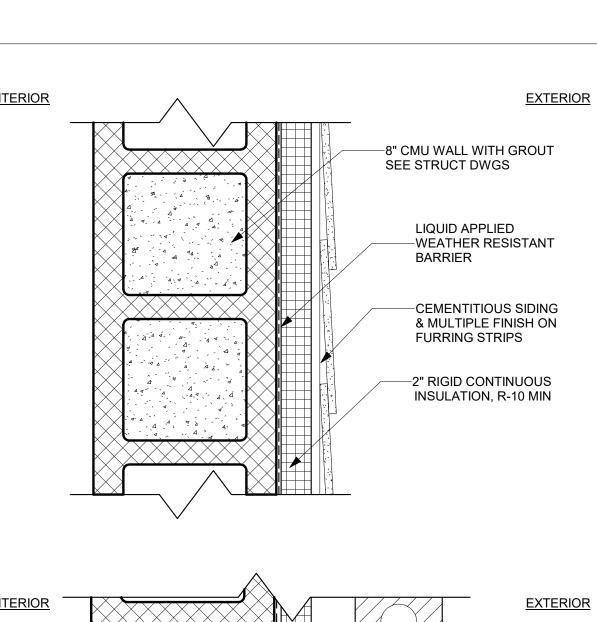
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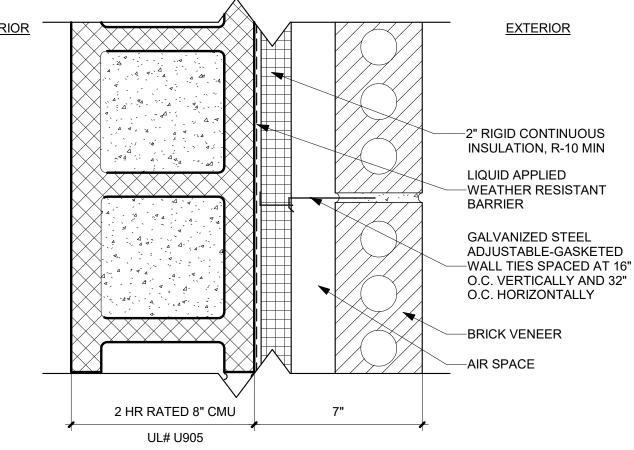


UL# U904 3-HR 8" CMU - ELEVATOR & STAIR ADJACENT TO INTERIOR WOOD STUD






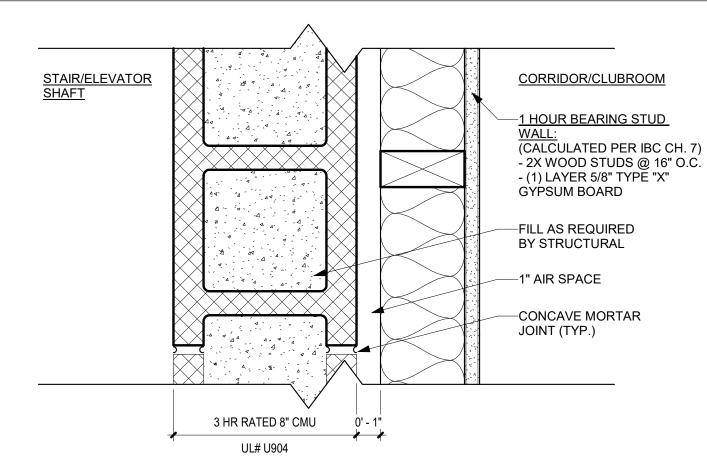


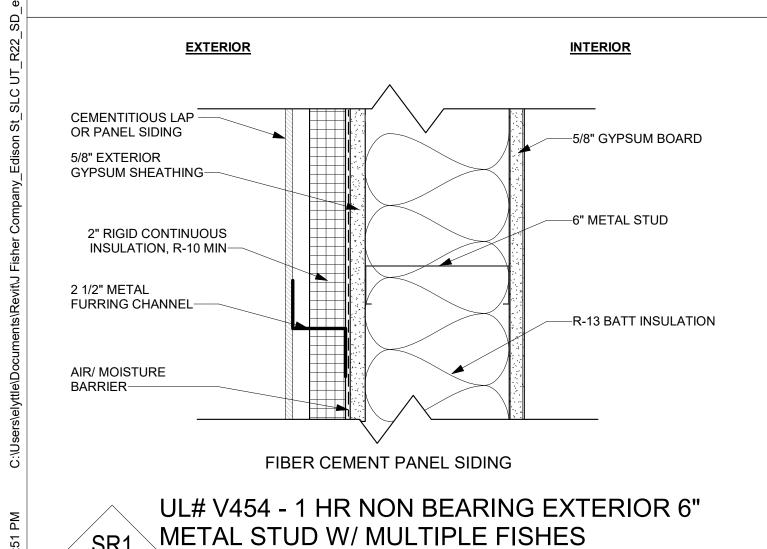



UL# U905 2-HR CMU W/ MULTIPLE MO2 FINISH CONDITIONS

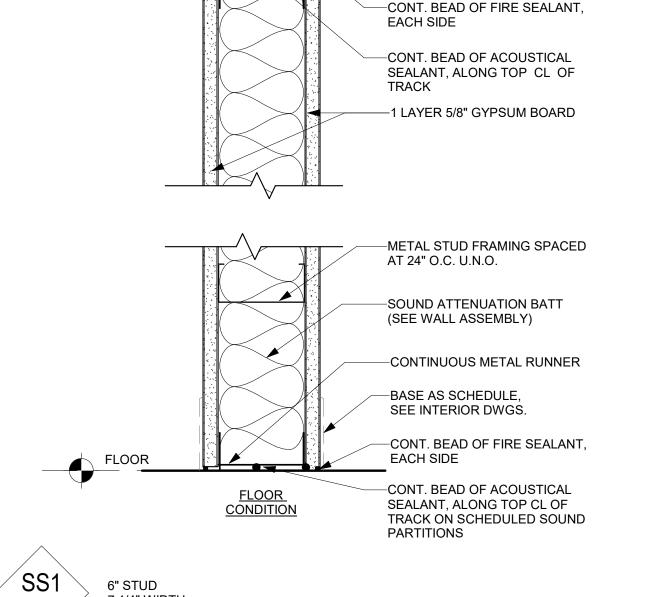



7 1/4" WIDTH UL# U465 1-HR RATED INTERIOR NON-BEARING METAL STUD WALL

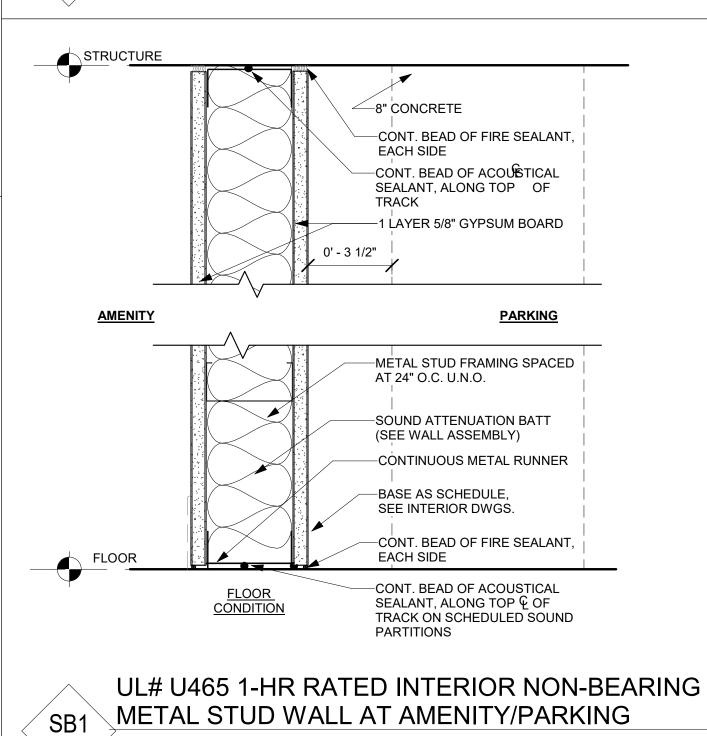


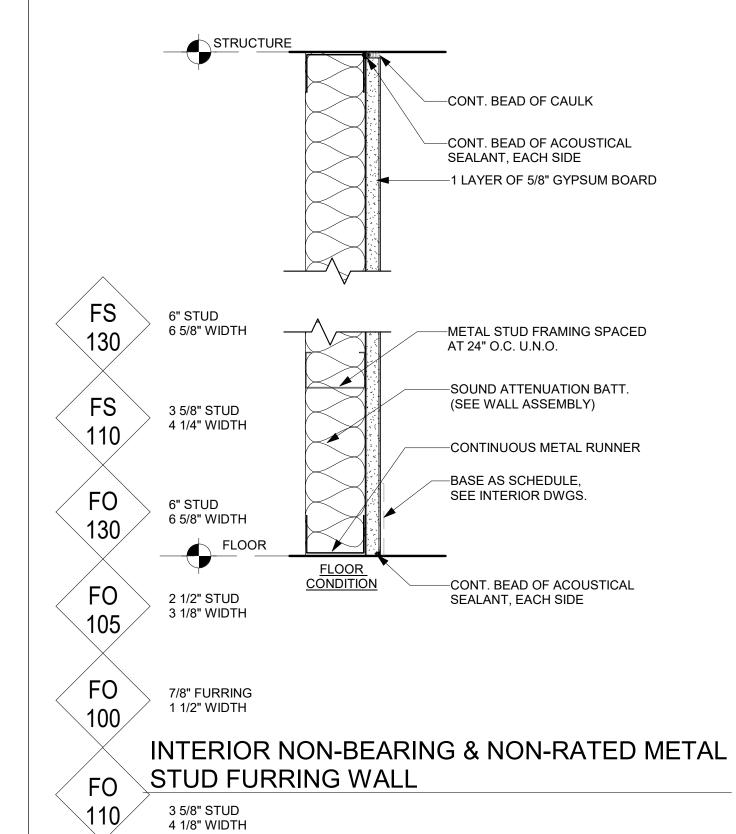

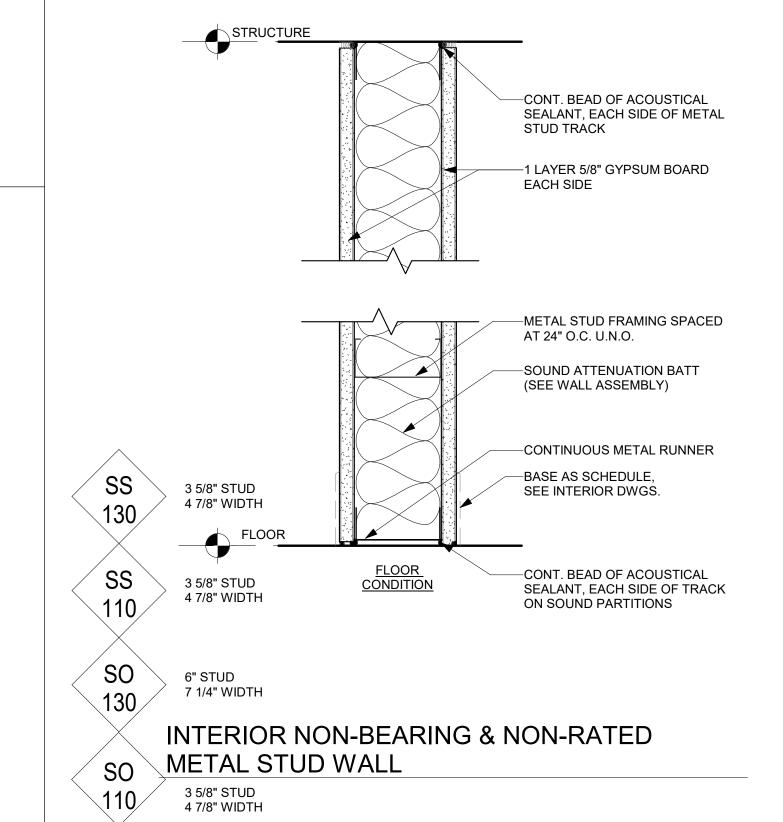


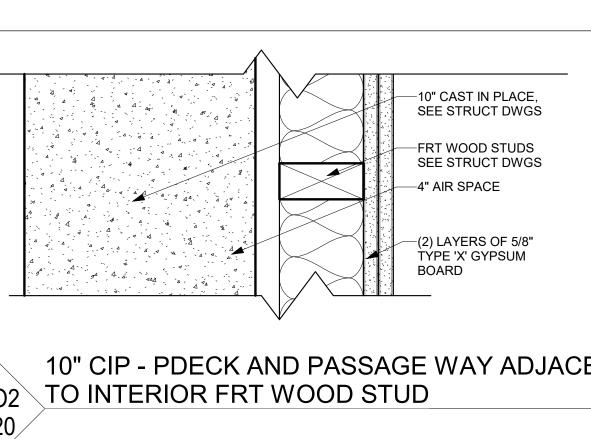


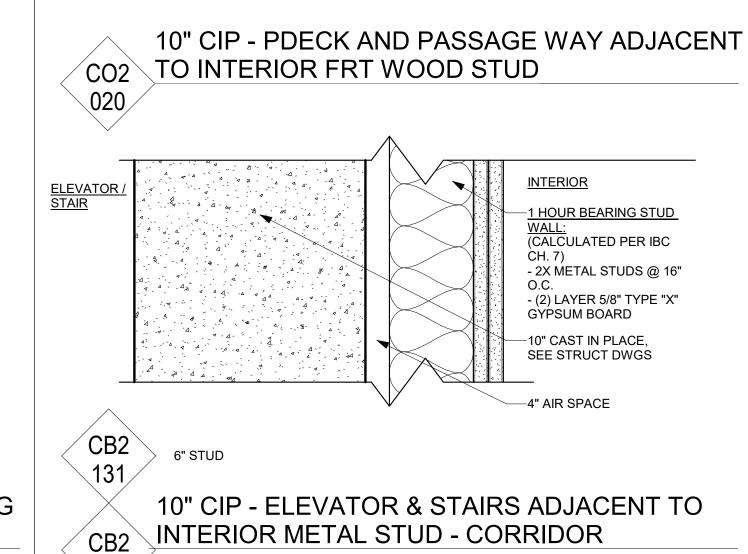

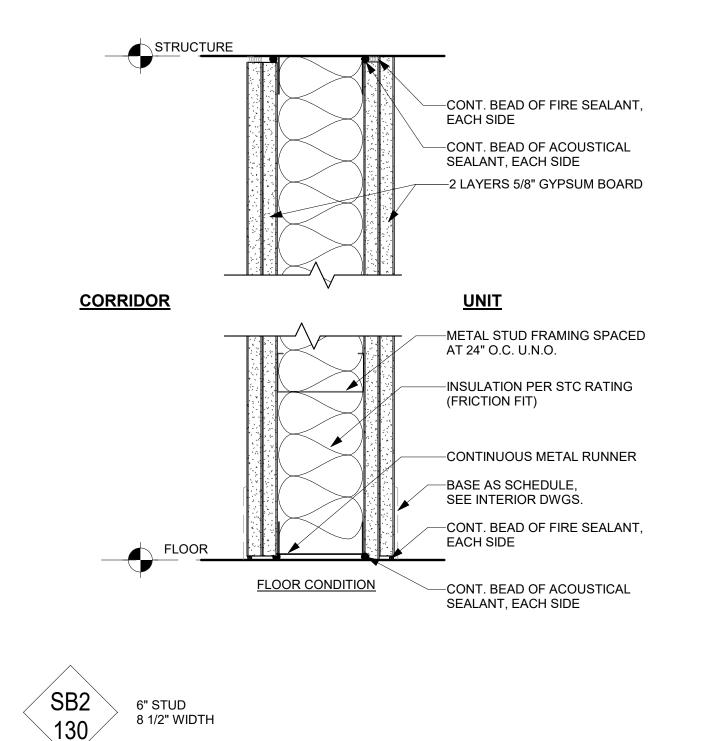



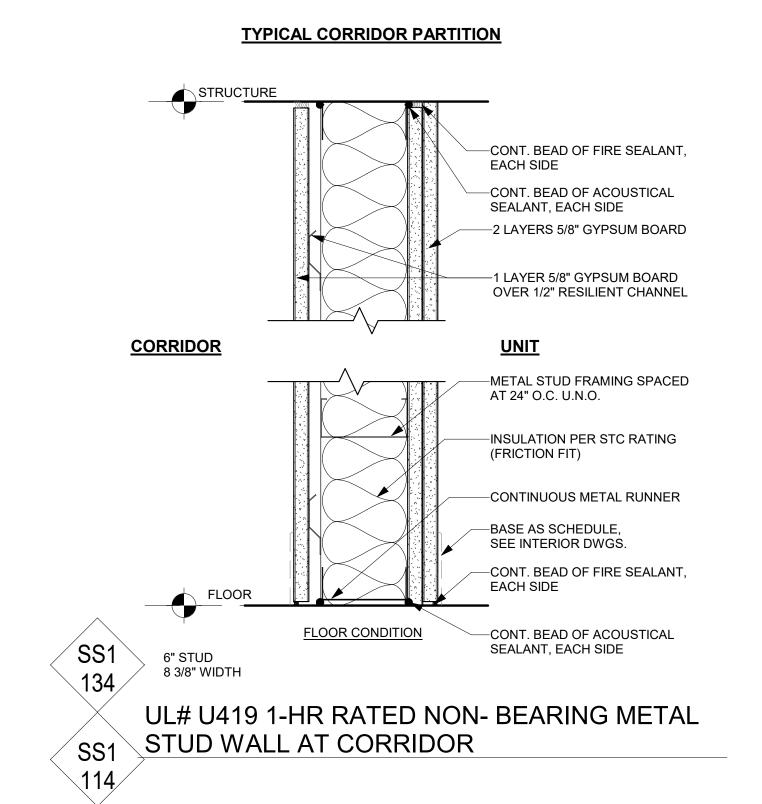

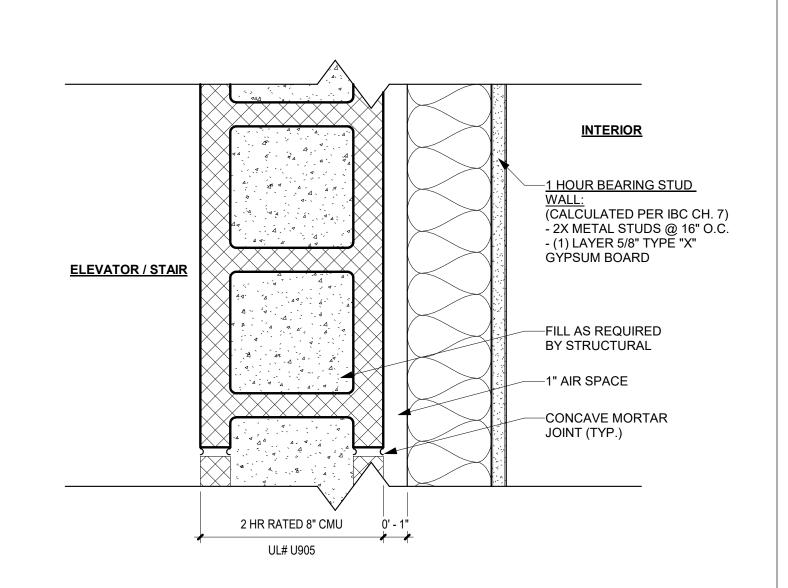

MB2 130 UL# 905 2-HR 8" CMU - ADJACENT TO INTERIOR METAL STUD

PARTITION NOTES

. DO NOT SCALE DRAWINGS

PARTITION AND MULLION.


- . ALL DIMENSION ARE FROM FACE OF STUD WALL TO FACE OF STUD WALL OR FROM CENTERLINE OF COLUMN TO FACE OF STUD WALL UNLESS NOTED OTHERWISE.
- 3. REFER TO PARTITION LEGEND AND PARTITION TAG FOR GRAPHIC SYMBOLS CLARIFICATION
- 4. THE CENTERLINE OF THE PARTITION SHOULD BE ALIGNED WITH THE CENTERLINE
- OF AN EXTERIOR WINDOW MULLION UNLESS NOTED OTHERWISE IN THE ARCHITECTURAL PLANS. PROVIDE NEOPRENE GASKET CLOSURE BETWEEN
- 5. CONTRACTOR TO VERIFY ALL DIMENSIONS IN FIELD AND NOTIFY THE ARCHITECT OF ANY DISCREPANCIES PRIOR TO PARTITION AND INSTALLATION.
- 6. SEE GENERAL NOTES FOR ADDITIONAL INFORMATION.
- ALL RATED WALLS MUST MEET REQUIREMENT OF THE INDICATED TEST NUMBER. . METAL STUD MUST SIZED AND SPACED SO AS NOT TO EXCEED L/240 DESIGN CRITERIA. MIN. STUD GAUGE = 25. PARTITIONS SHALL BE LIMITED IN HEIGHT IN ACCORDANCE WITH STM C754.
- REFER TO THE REFLECTED CEILING PLANS AND ARCHITECTURAL DRAWINGS FOR INDICATION OF WHICH NON-RATED PARTITIONS EXTEND TO CEILING HEIGHT OR TO UNDERSIDE OF STRUCTURE. IF DISCREPANCY EXIST, G.C. TO CONTACT
- 10. WHERE NON-RATED PARTITIONS DO NOT EXTEND TO STRUCTURE, STOP GWB 6" ABOVE CEILING AND EXTEND OR BRACE METAL STUDS TO STRUCTURE. 11. PROVIDE MAX. 16" O.C. STUD SPACING BEHIND ALL CERAMIC TILE OR STONE VENEER WALLS.
- 12. PROVIDE UL APPROVED FIRE RESISTANT GWB WHERE REQUIRED BY RATING. 13. APPLY ACOUSTICAL SEALANT ALONG CENTERLINE OF STUD TRACKS TO ENTIRE PERIMETER OF ALL DEMISING AND CORRIDOR WALLS.
- 14. PROVIDE FIRE RATED SEALANT TO BOTH SIDES OF ENTIRE PERIMETER OF FIRE RATED WALLS AND AROUND ALL PENETRATIONS TO APPLICABLE U.L. LISTING REQUIREMENT OF WALL BEING PENETRATED
- 15. CONTRACTOR TO STAGGER ALL ELECTRICAL, COMMUNICATIONS, TELEPHONE AND OTHER SIMILAR OUTLET BOXES AT A MIN. OF 12" O.C. IN FIRE RATED AND SOUND RATED WALLS.
- 16. G.C. TO PROVIDE PUTTY PADS ON ALL ELECTRICAL OUTLET BOXES ON FIRE AND SOUND RATED WALLS. 17. REFER TO I.D. DRAWINGS FOR LOCATION OF ALL INTERIOR FINISHES.
- 18. PROVIDE WATER RESISTANT GWB AT ALL SHOWER AND BATH TUB WALL SURROUNDS (DENS-SHIELD OR APPROVED EQUAL).
- 19. PROVIDE IN-WALL BLOCKING FOR ALL CABINETRY, TOILET ACCESSORIES, CLOSET SHELVING, MILLWORK, WALLSTOPS, ARTWORK, WALL BUMPERS/GUARDS, DRAPERY LOCATIONS, STONEWORK, GRAB BARS, MODULAR OFFICE WALLS, AND OTHER SIMILAR CONDITIONS.
- 20. THE U.L. NUMBER INDICATED REFERENCE VOLUME 1, 2 AND 2B OF THE MOST RECENT FIRE RESISTANCE DIRECTORY PUBLISHED BY UNDERWRITERS LABORATORIES INC. - SEE SHEET CD-80 TO CD-86 FOR MORE INFORMATION.
- 21. ALL THROUGH WALL PENETRATIONS OF FIRE RATED WALLS/PARTITIONS MUST BE SEALED WITH FIRESTOP SYSTEM APPROVED BY U.L. FOR PENETRATIONS IN APPLICABLE WALL OR AS NOTED BY ARCHITECT. SEE ARCH/MEP DRAWINGS FOR ADDITIONAL INFORMATION.
- 22. DEFLECTION TRACKS TO BE PROVIDED AT TOP RUNNERS OF ALL METAL STUDS PARTITIONS THAT EXTEND TO UNDERSIDE OF STRUCTURAL DECK. TRACK MUST BE DESIGNED TO ALLOW UP TO 1/2" DEFLECTION. 23. ALL SMOKE AND FIRE RATED PARTITIONS MUST BE IDENTIFIED WITH PAINTED
- 24. WALLS THAT EXTEND "TO STRUCTURE" SHALL EXTEND TO UNDERSIDE OF C.I.P CONCRETE SLAB METAL DECK OR PRECAST. 25. PROVIDE FIRE TREATED WOOD BLOCKING OR PLYWOOD INSIDE WALLS AND

STENCILS ABOVE CEILINGS.

- OTHER CONCEALED SPACES. CONTRACTOR TO COORDINATE PARTITION LAYOUT WITH M.E.P. WORK AND NOTIFY ARCHITECT OF ANY DISCREPANCIES PRIOR TO INSTALLATION OF
- 27. CONTRACTOR TO VERIFY SIZE AND LOCATION OF ALL EQUIPMENT 28. COORDINATE LOCATIONS OF FIRE PULL STATIONS, FIRE STROBES/SPEAKERS AND FIREMAN'S TELEPHONE JACK WITH INTERIOR DESIGN ELEMENTS. 29. VERIFY ALL THERMOSTAT LOCATIONS WITH INTERIOR DESIGNER FOR

METAL/PLUMBING SLEEVES AT TIME OF CONCRETE PLACEMENT.

- COORDINATION WITH DESIGN ELEMENTS PRIOR TO INSTALLATION. 30. REFER TO ELECTRICAL DRAWINGS FOR POWER, TELEPHONE, AND DATA OUTLET LOCATIONS.
- 31. SEAL ALL SOUND PARTITIONS WITH ACOUSTICAL SEALANT AT BASE, HEAD, AND ALL PENETRATIONS. 32. ALL EXPOSED TOP EDGES OF WALLS OR WHERE WALL ABUTS COLUMN OR
- OTHER CONCRETE STRUCTURE TO HAVE A ZIP BEAD FINISH. 33. G.C. TO PROVIDE A ZIP BEAD FINISH ALONG THE TOP EDGE OF ALL WALL WHERE WALL ABUTS AN EXPOSED OR SKIM COAT FINISH COLUMN AND OR CONCRETE
- 34. SOME WALL INDICATED MAY REQUIRE AN EXTERIOR FINISH SYSTEM NOT INDICATED ON PARTITION SCHEDULE. SEE ARCHITECTURAL DRAWING ADDITIONAL
- 35. IN TYPICAL TOWER RESIDENTIAL UNITS, GWB ON WALL TO STOP AT GWB CEILINGS (STUDS TO CONTINUE TO STRUCTURE) EXCEPT AT CEILING BATHROOMS AND MECHANICAL CLOSETS, BOTH STUDS AND GWB WILL EXTEND TO STRUCTURE. 36. WALL TYPE IS BASED ON USG CRITERIA.
- 37. CAVITIES OF ALL CMU INTERIOR AND/OR EXTERIOR WALL ADJACENT TO HEATED SPACES TO RECEIVE MIN. R19 SPRAY FOAM INSULATION, TYP.

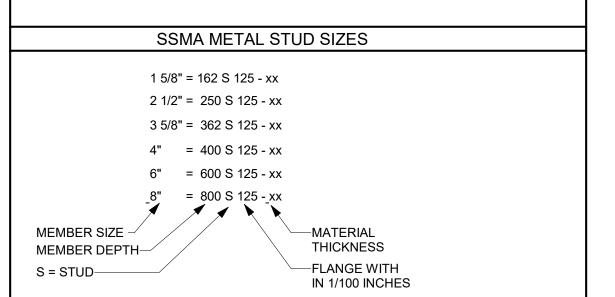

WALL TYPE LEGEND:

1ST LETTER INDICATES STRUCTURAL MATERIAL C POURED IN PLACE CONCRETE F METAL FURRING / WOOD FURRING



P PRECAST CONCRETE S METAL STUD / CHANNEL W WOOD

2ND LETTER INDICATES INSULATION O NONE B BATT INSULATION D BATT + BOARD INSULATION

R BOARD INSULATION S SOUND

FIRE RATING 1 1 HOUR 2 2 HOUR 3 3 HOUR

4 4 HOUR

Structural Number Component Size & Composition Material Designation

if Applicable Stud if Applicable C,F,M,P,S,W 10-19 MATERIAL + < 2x4 WOOD STUD MATERIAL + 2x4 WOOD STUD 20-39 MATERIAL + 2x6 WOOD STUD > 2x6 WOOD STUD MATERIAL + 2x4 WOOD STUD EACH SIDE 70-79 MATERIAL + 2x6 WOOD STUD EACH SIDE 90-99 MATERIAL VARYING DOUBLE STUD CONDITIONS C,F,M,P,S,W 100-109 MATERIAL + < 3 5/8" METAL STUD 110-129 MATERIAL + 3 5/8" =< 6" METAL STUD 130-149 MATERIAL + >= 6" METAL STUD 150-159 MATERIAL + 3 5/8"=< 6" METAL STUD EACH SIDE 160-169 MATERIAL + >=6" METAL STUD EACH SIDE C,M,P,S,W 170-179 MATERIAL + VARYING DOUBLE STUD CONDITIONS 180-189 OTHER MASONRY

*FIRE AND SOUND TEST NUMBERS BASED ON THE FOLLOWING:

- FIRE RESISTANCE DIRECTORY 2019 EDITION BY UL (UNDERWRITERS LAB INC.) - FIRE RESISTANCE, AND SOUND CONTROL DESIGN MANUAL 22ND EDITION 2019 BY GYPSUM ASSOCIATIONS.

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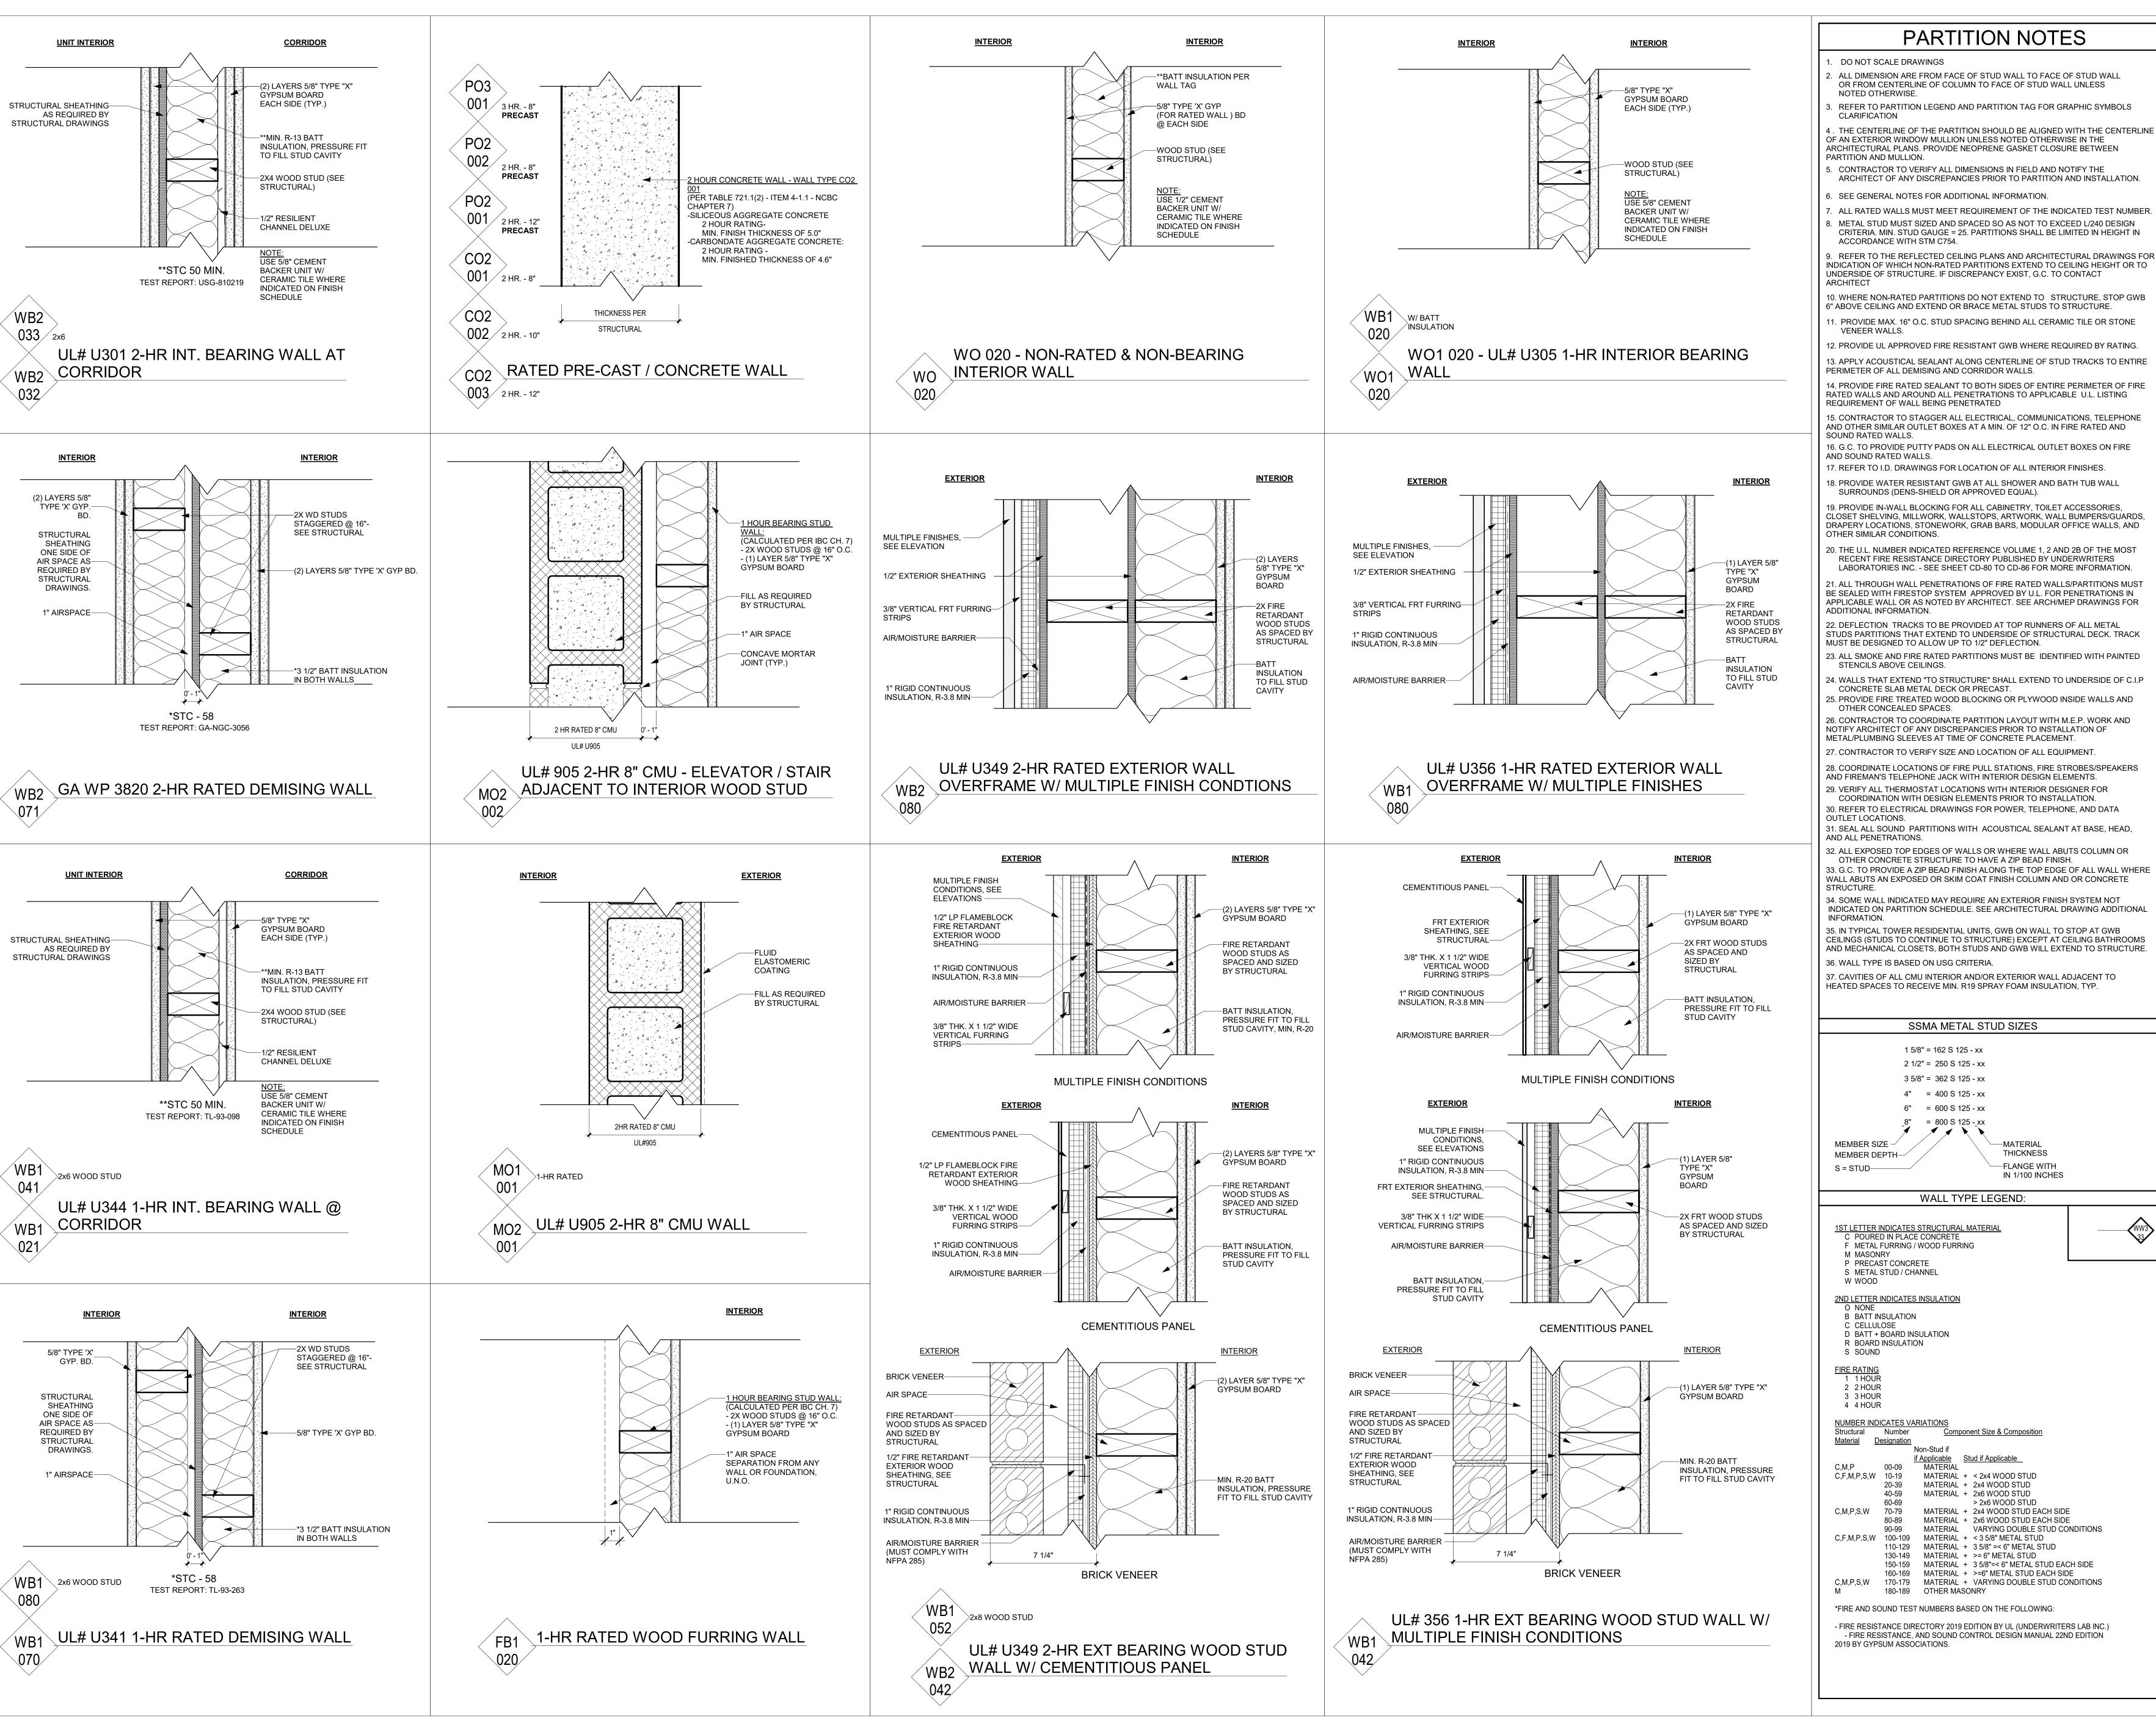
ISSUE 07/14/2023 SCHEMATIC DESIGN

REVISION

SHEET NAME: WALL **PARTITION DETAILS**

JOB NUMBER: 2249901

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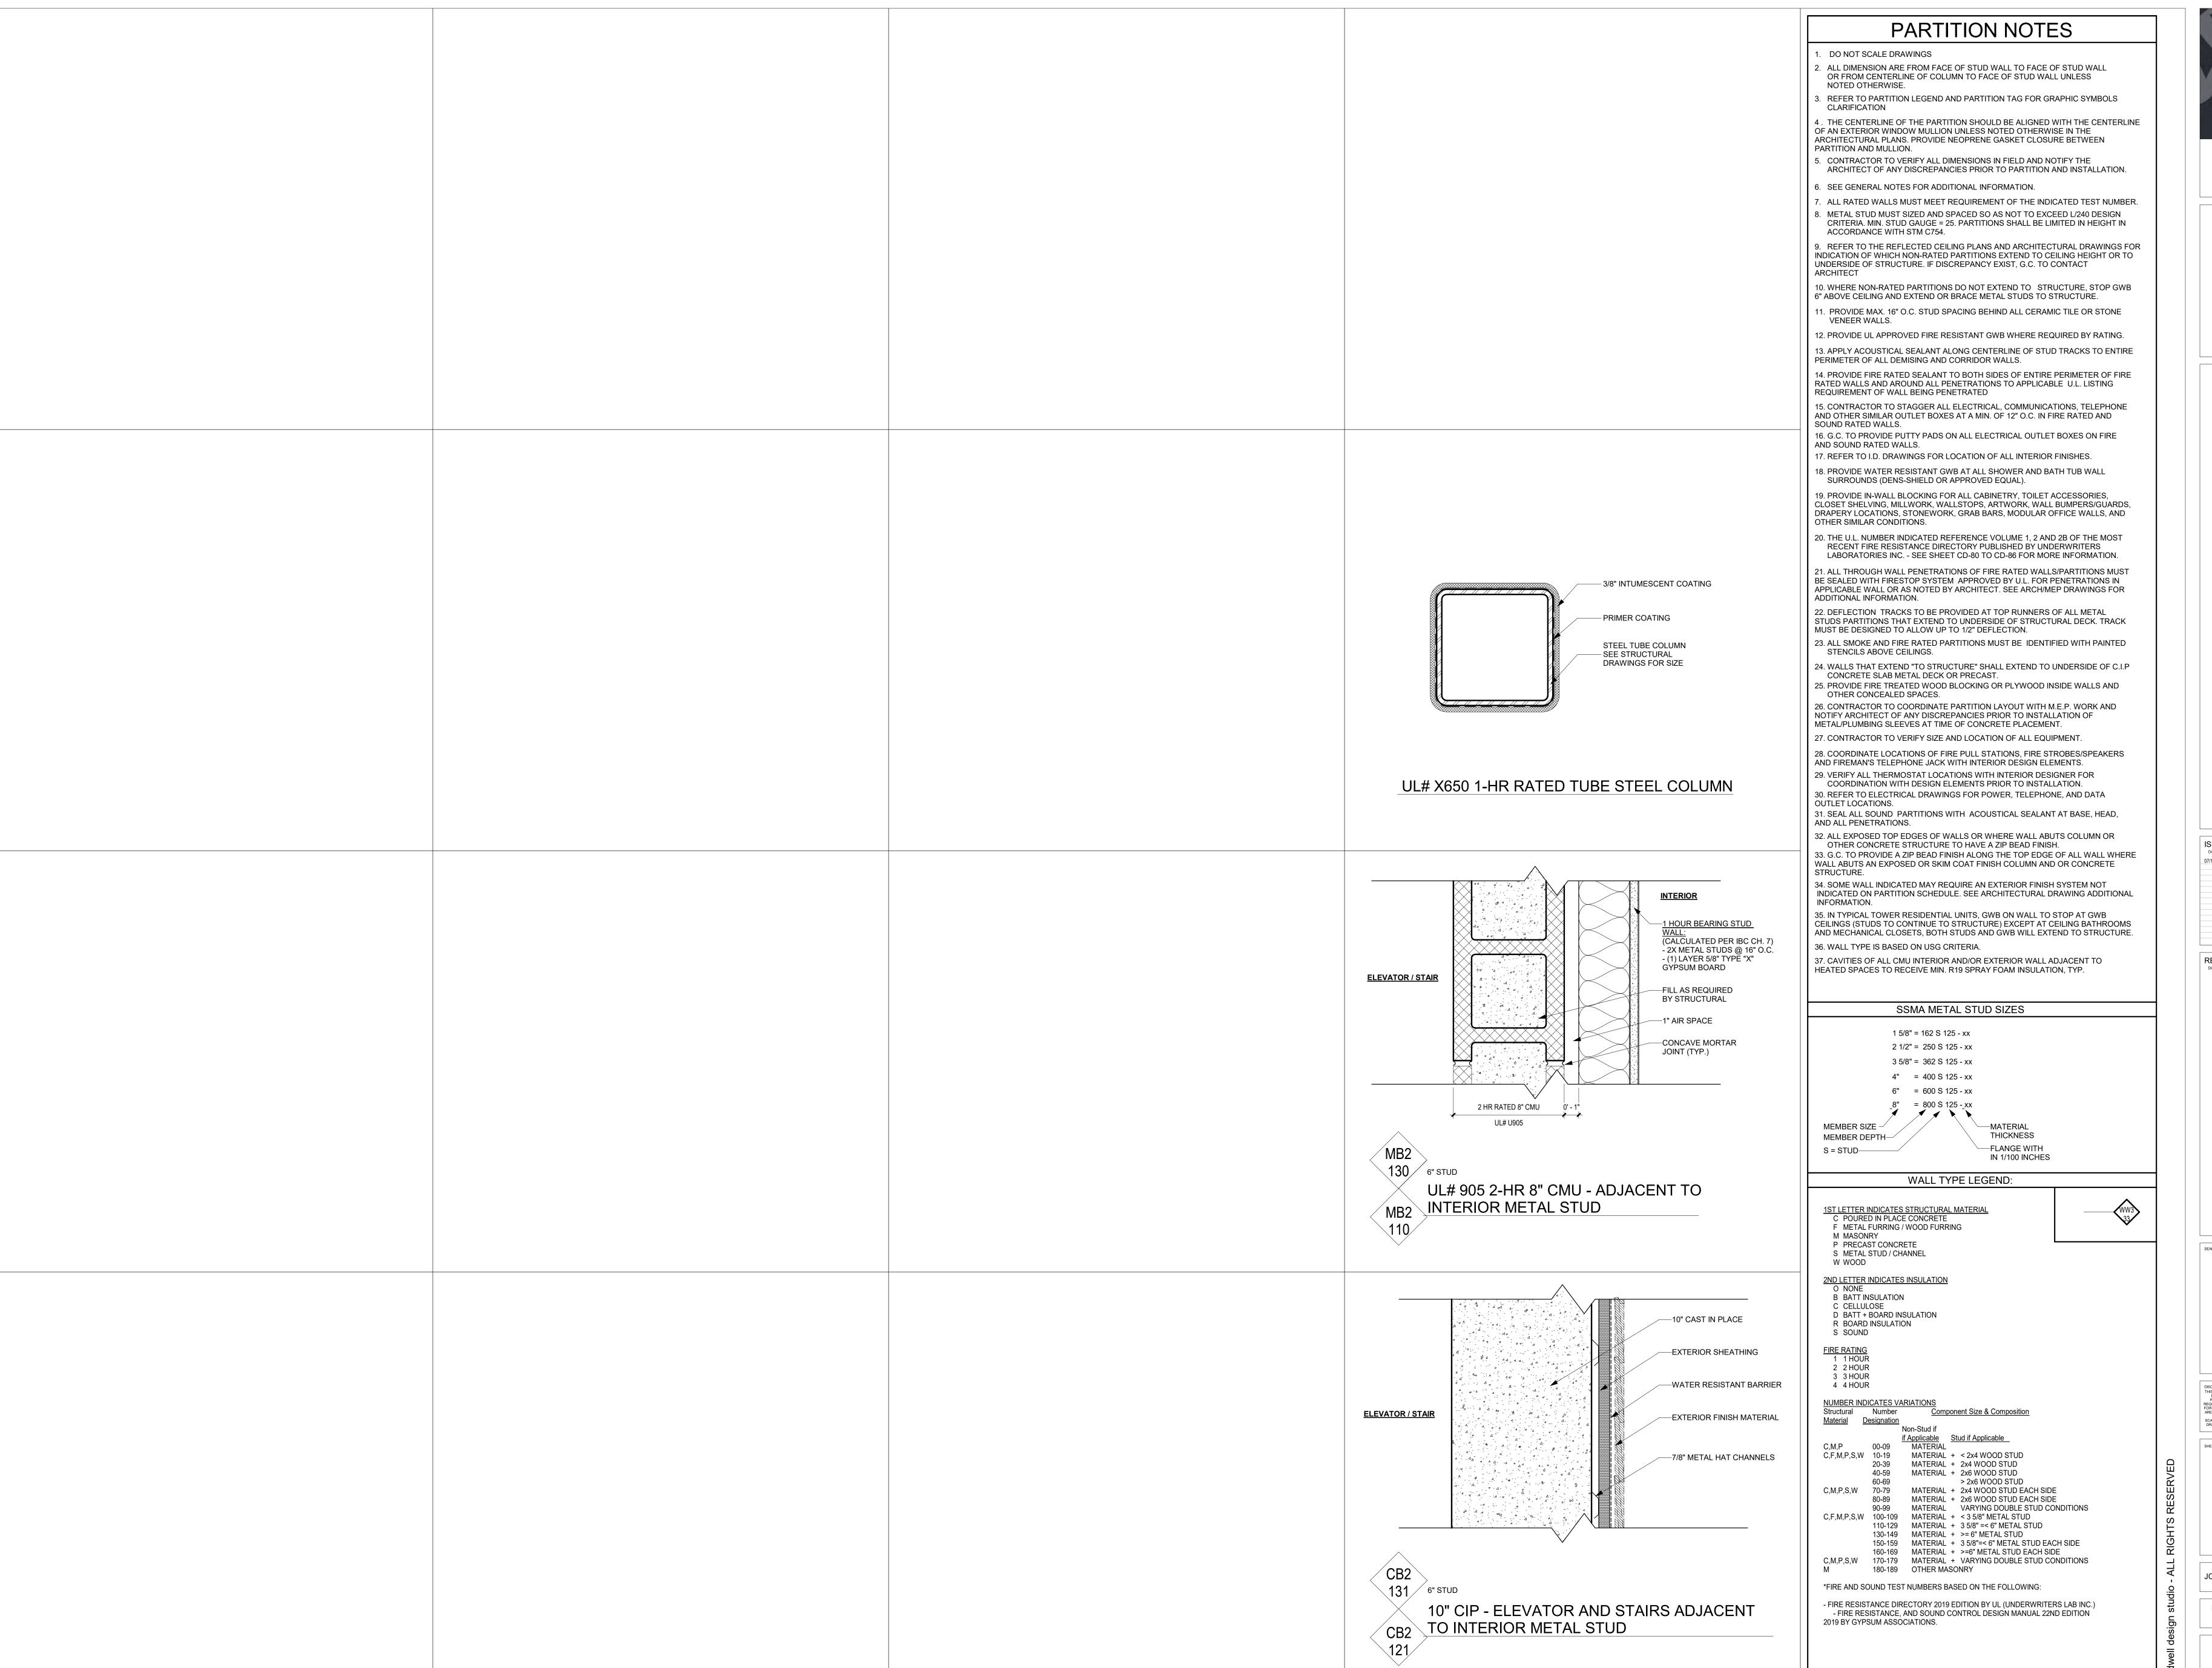
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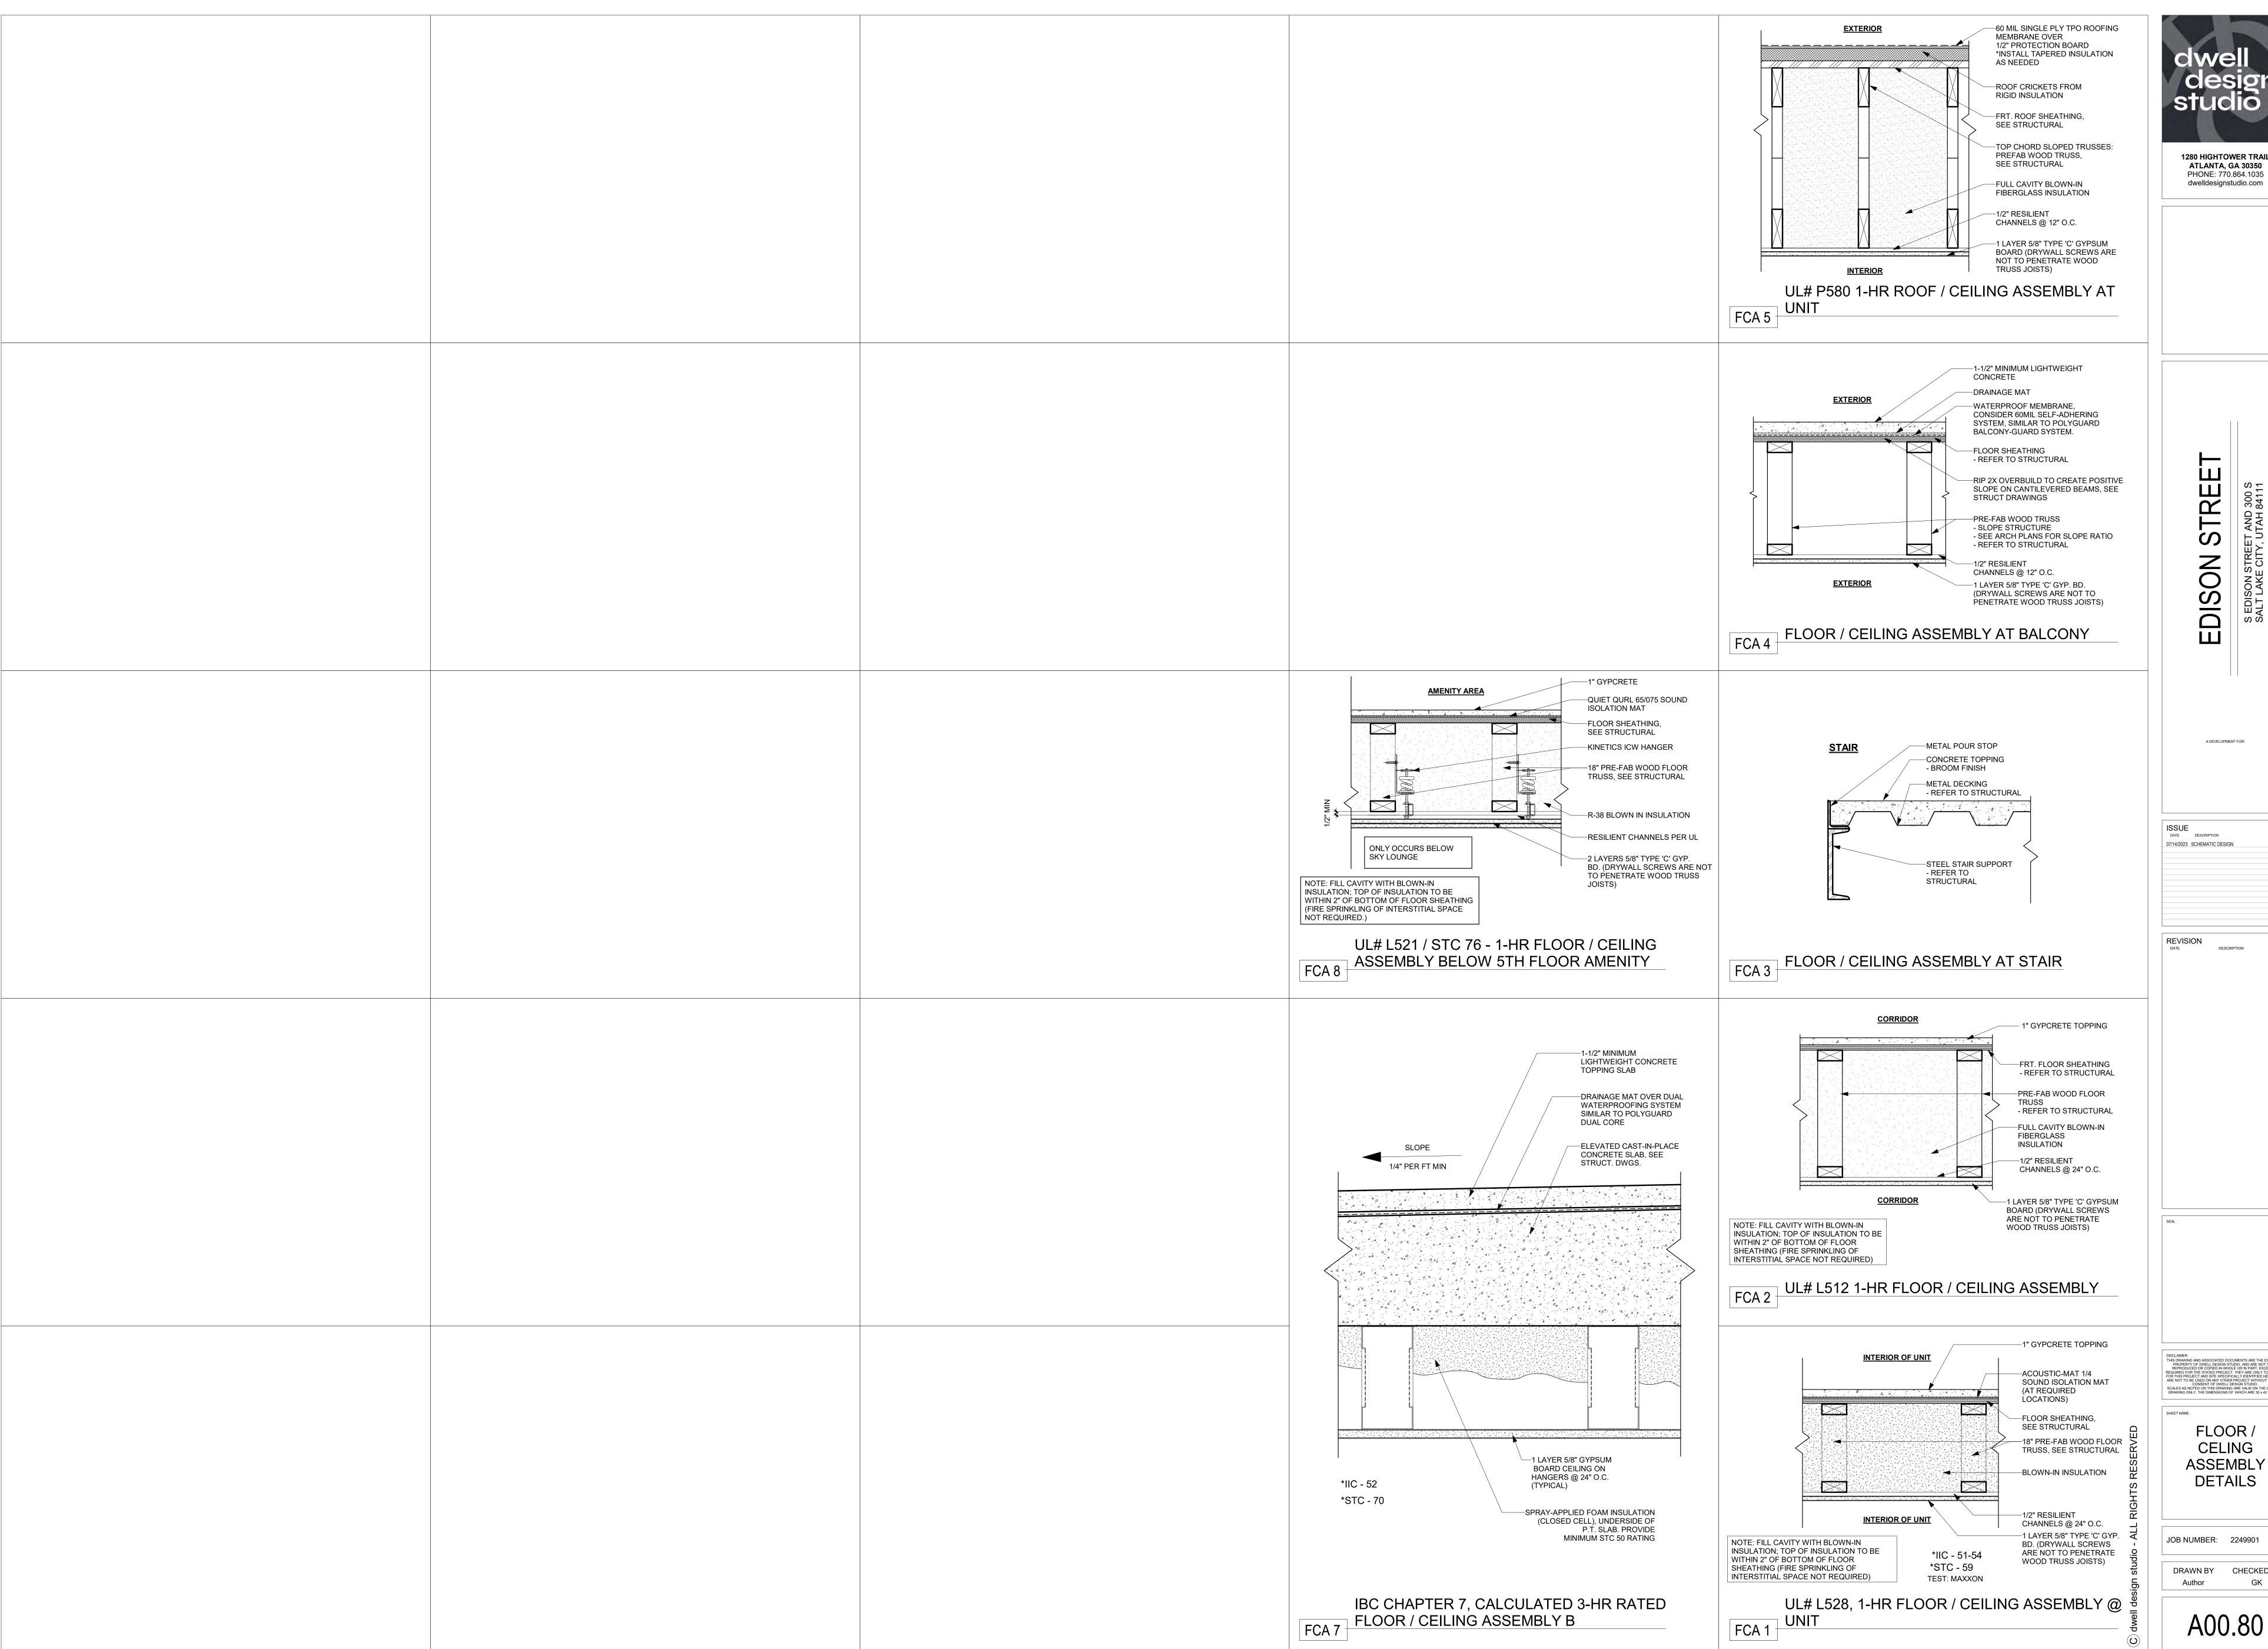
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1 OVERALL BUILDING PLAN - BASEMENT LEVEL

1/16" = 1'-0"

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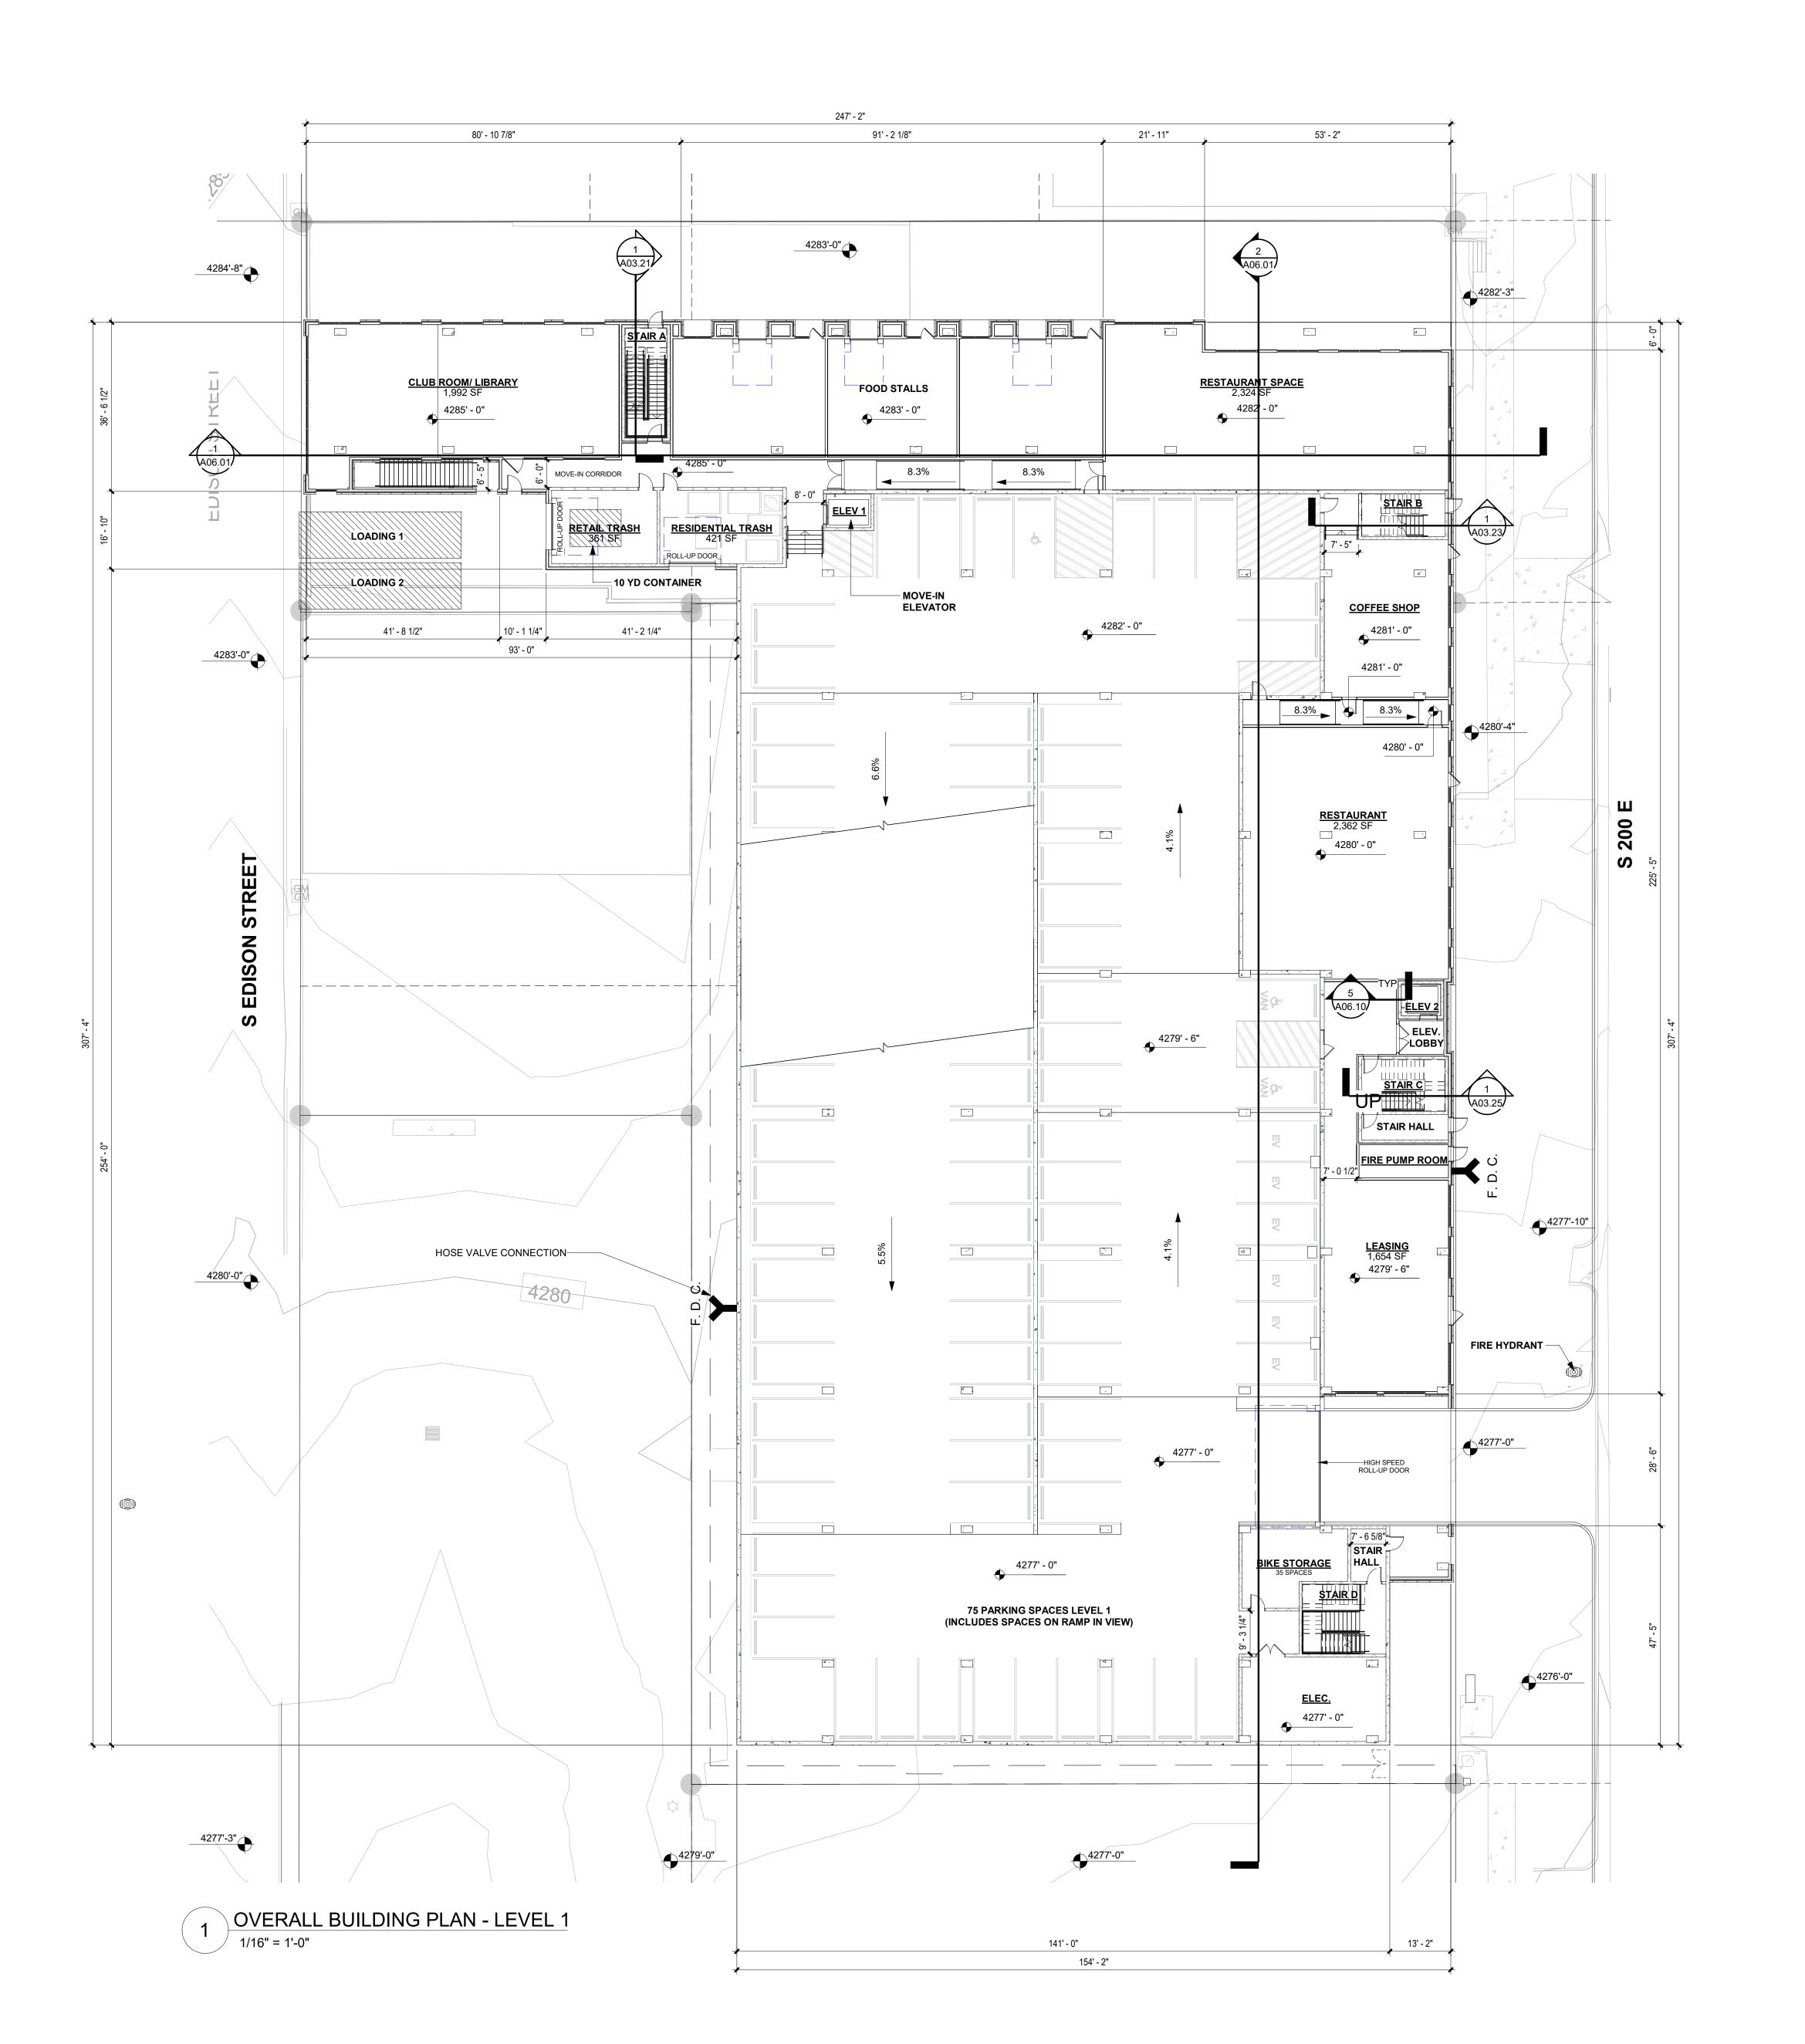
OVERALL PLAN
- BASEMENT

JOB NUMBER: 2249901

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PARKING NOTES / CALCS D-1 RESIDENTIAL PARKING: NO MINIMUM STUDIOS & 1 BEDS: 2 SP / DU MAX 447 MAX 225 PROVIDED 2 & 3 BEDS: 3 SP / DU MAX 447 MAX 225 PROVIDED **COMMERCIAL PARKING:** RESTAURANT: 2 SP / 1000 SF MAX 6 REQUIRED 6 PROVIDED TAVERN: 2 SP / 1000 SF MAX 6 REQUIRED 6 PROVIDED OUTDOOR SEATING: 4 SP / 1000 SF MAX 6 REQUIRED 6 PROVIDED RETAIL: NO MINIMUM, 2 SP / 1000 SF MAX 3 REQUIRED3 PROVIDED EV SPACES: 1 SPACE PER EVERY 25 SPACES MIN. 10 REQUIRED 13 PROVIDED ACCESSIBLE PARKING SPACES: 101-500: 1 PER 50 MIN. 5 REQUIRED 7 PROVIDED BICYCLE PARKING: 1 PER 2 UNITS MINIMUM 99 REQUIRED

101 PROVIDED



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OVERALL PLAN - LEVEL 1

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OVERALL PLAN

- LEVEL 2

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OVERALL PLAN
- LEVEL 3

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1 OVERALL BUILDING PLAN - LEVEL 3
1/16" = 1'-0"

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OVERALL PLAN
- LEVEL 4

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1 OVERALL BUILDING PLAN - LEVEL 4
1/16" = 1'-0"

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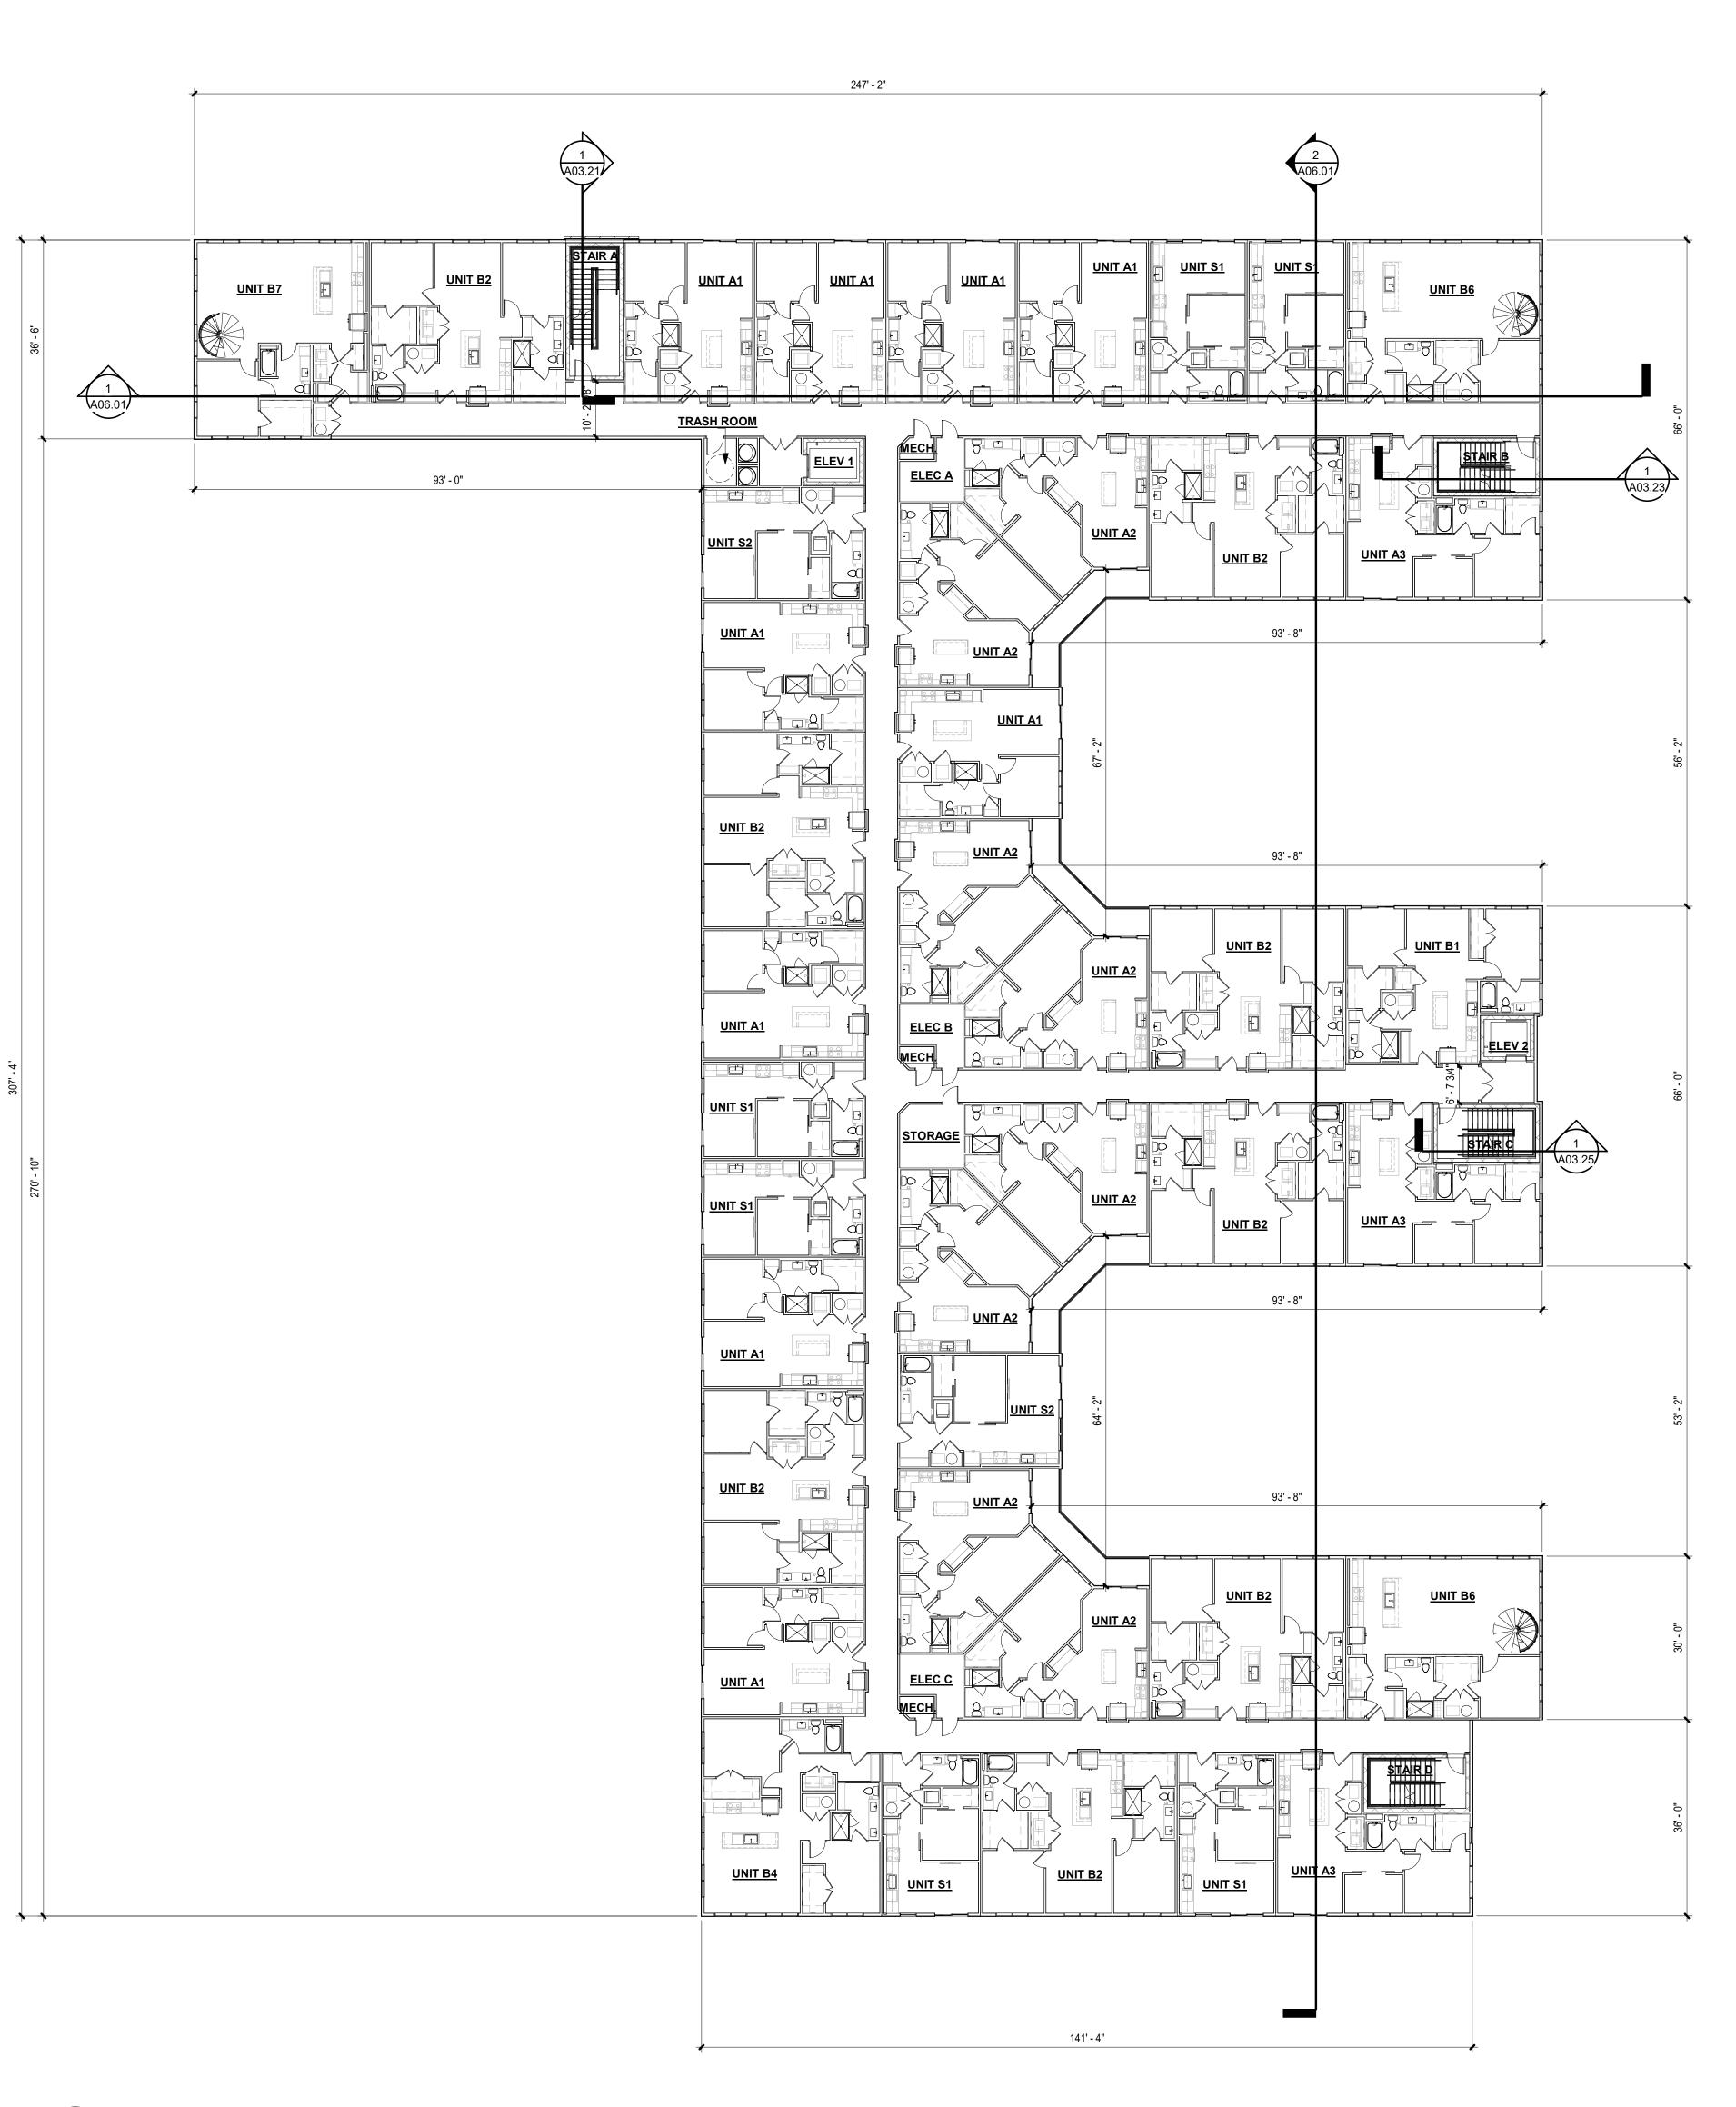
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OVERALL PLAN - LEVEL 5

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1 OVERALL BUILDING PLAN - LEVEL 6
1/16" = 1'-0"

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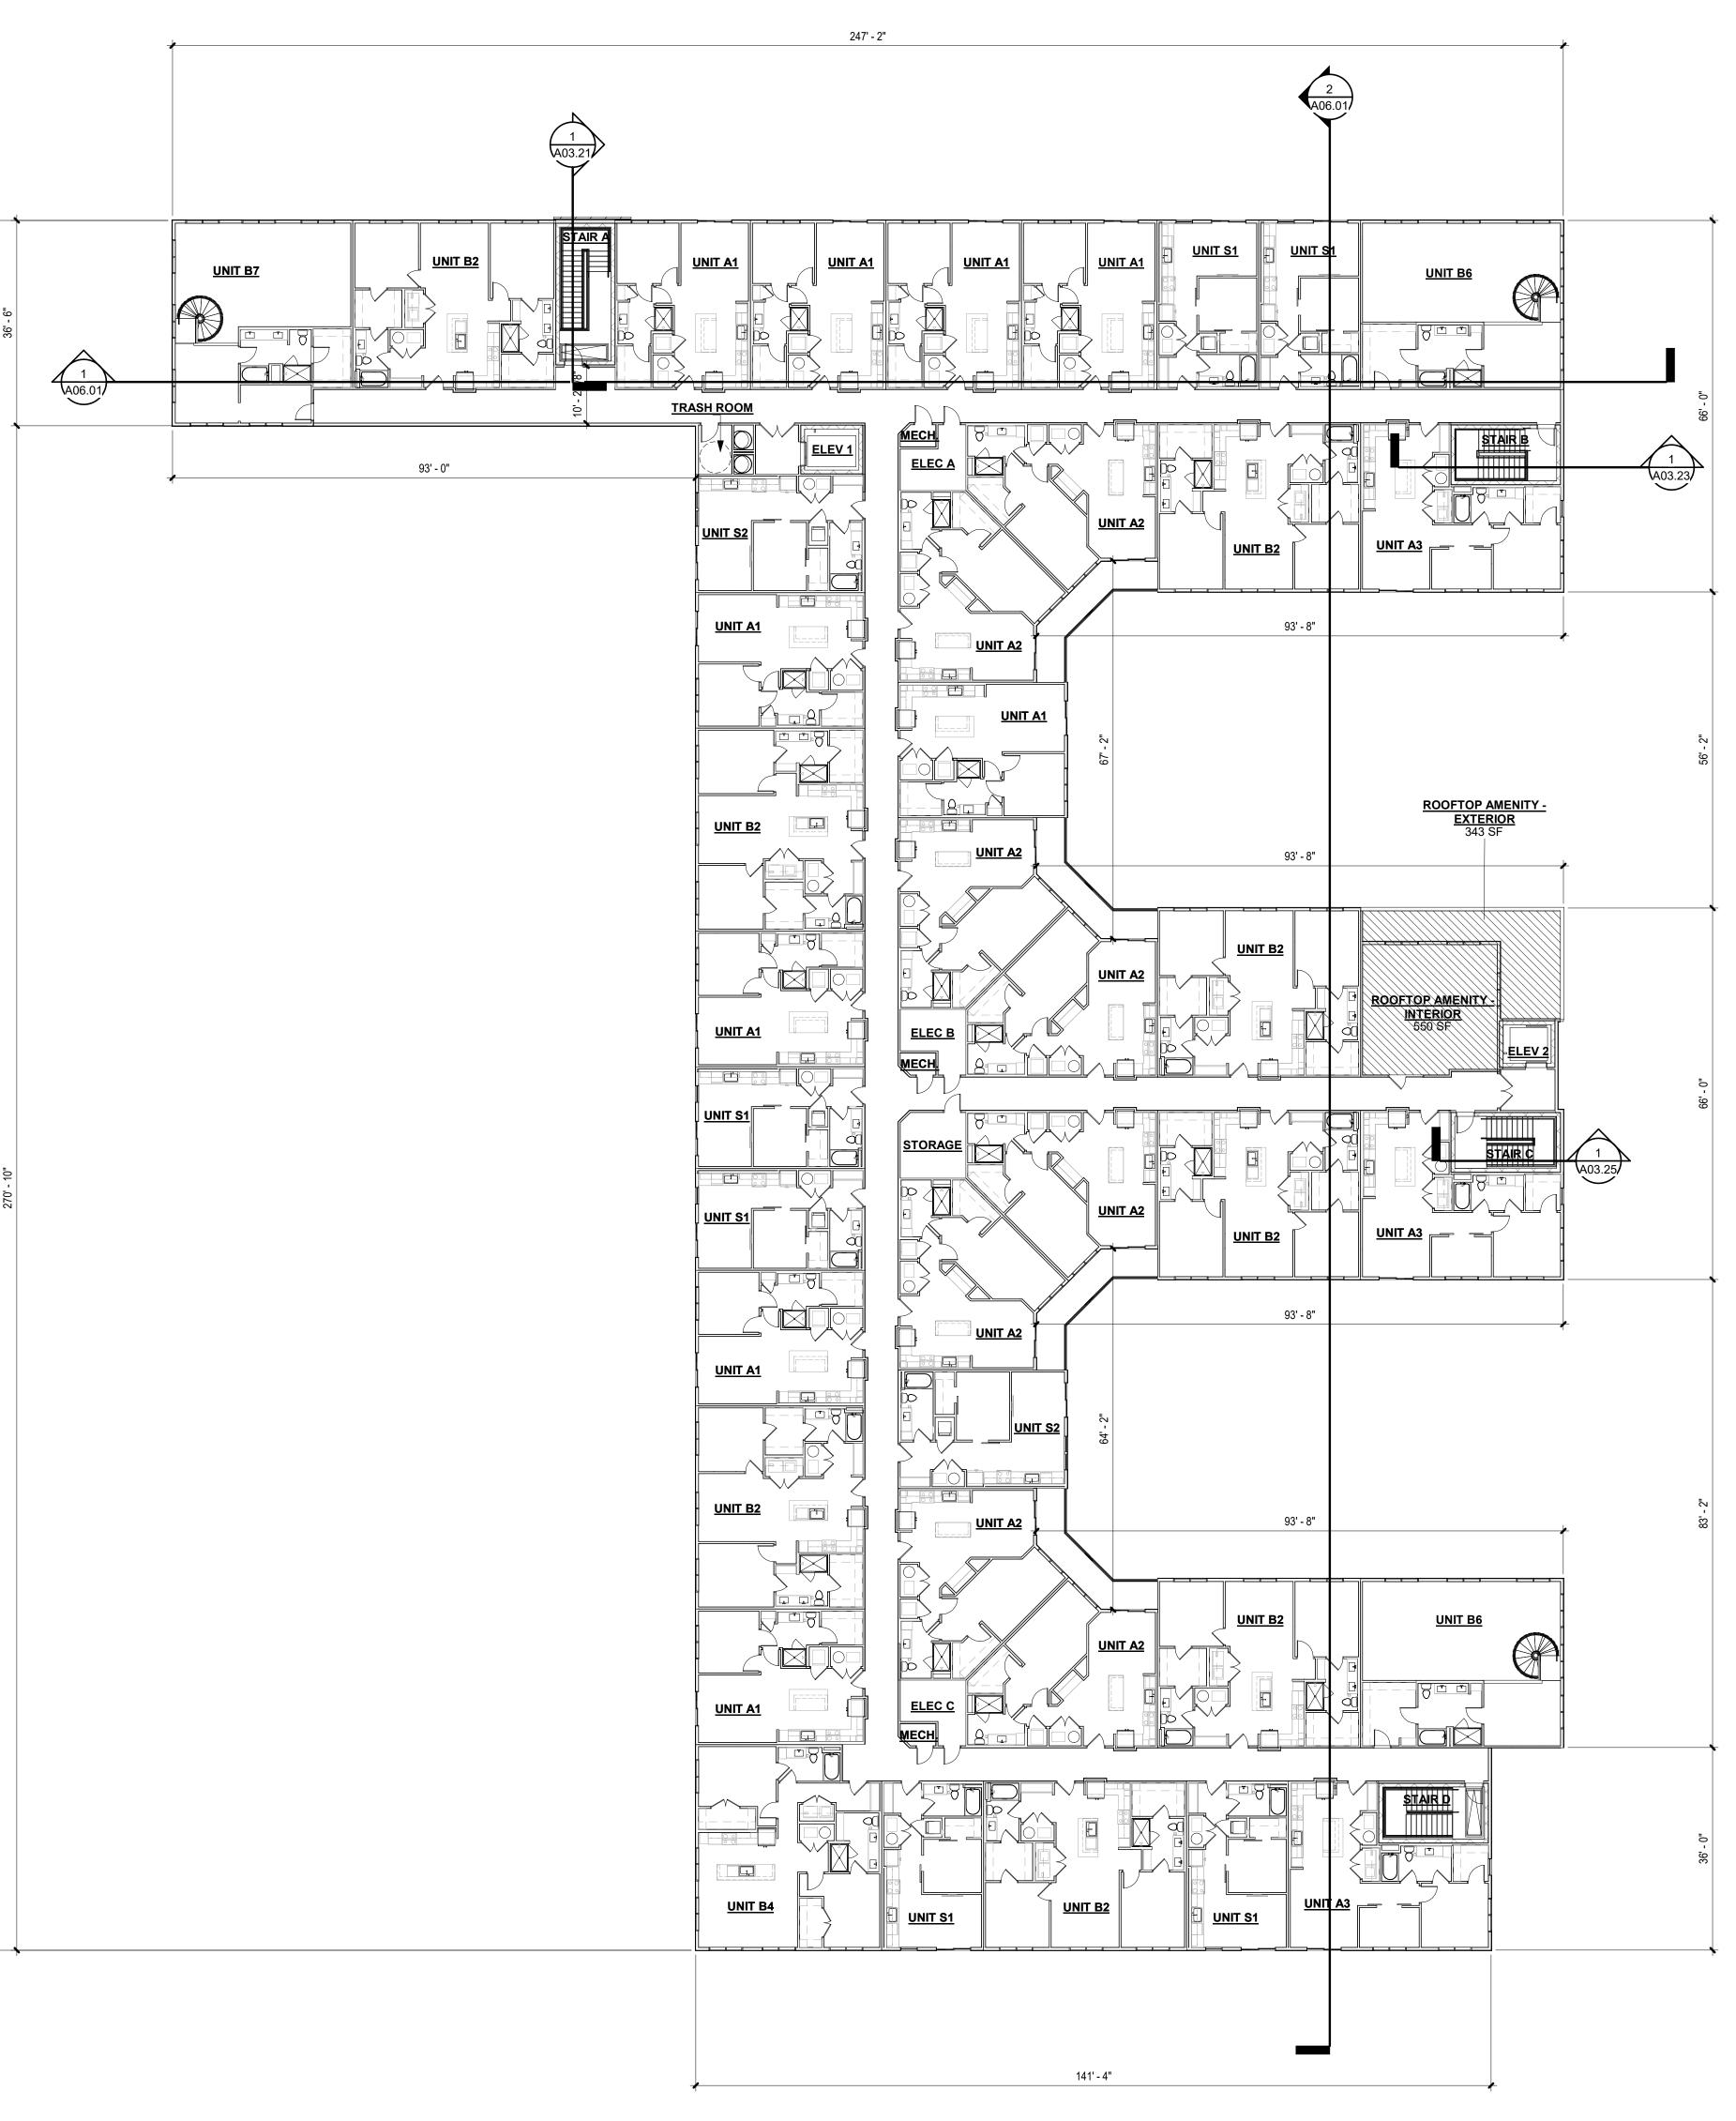
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OVERALL PLAN - LEVEL 6

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OVERALL PLAN - LEVEL 7

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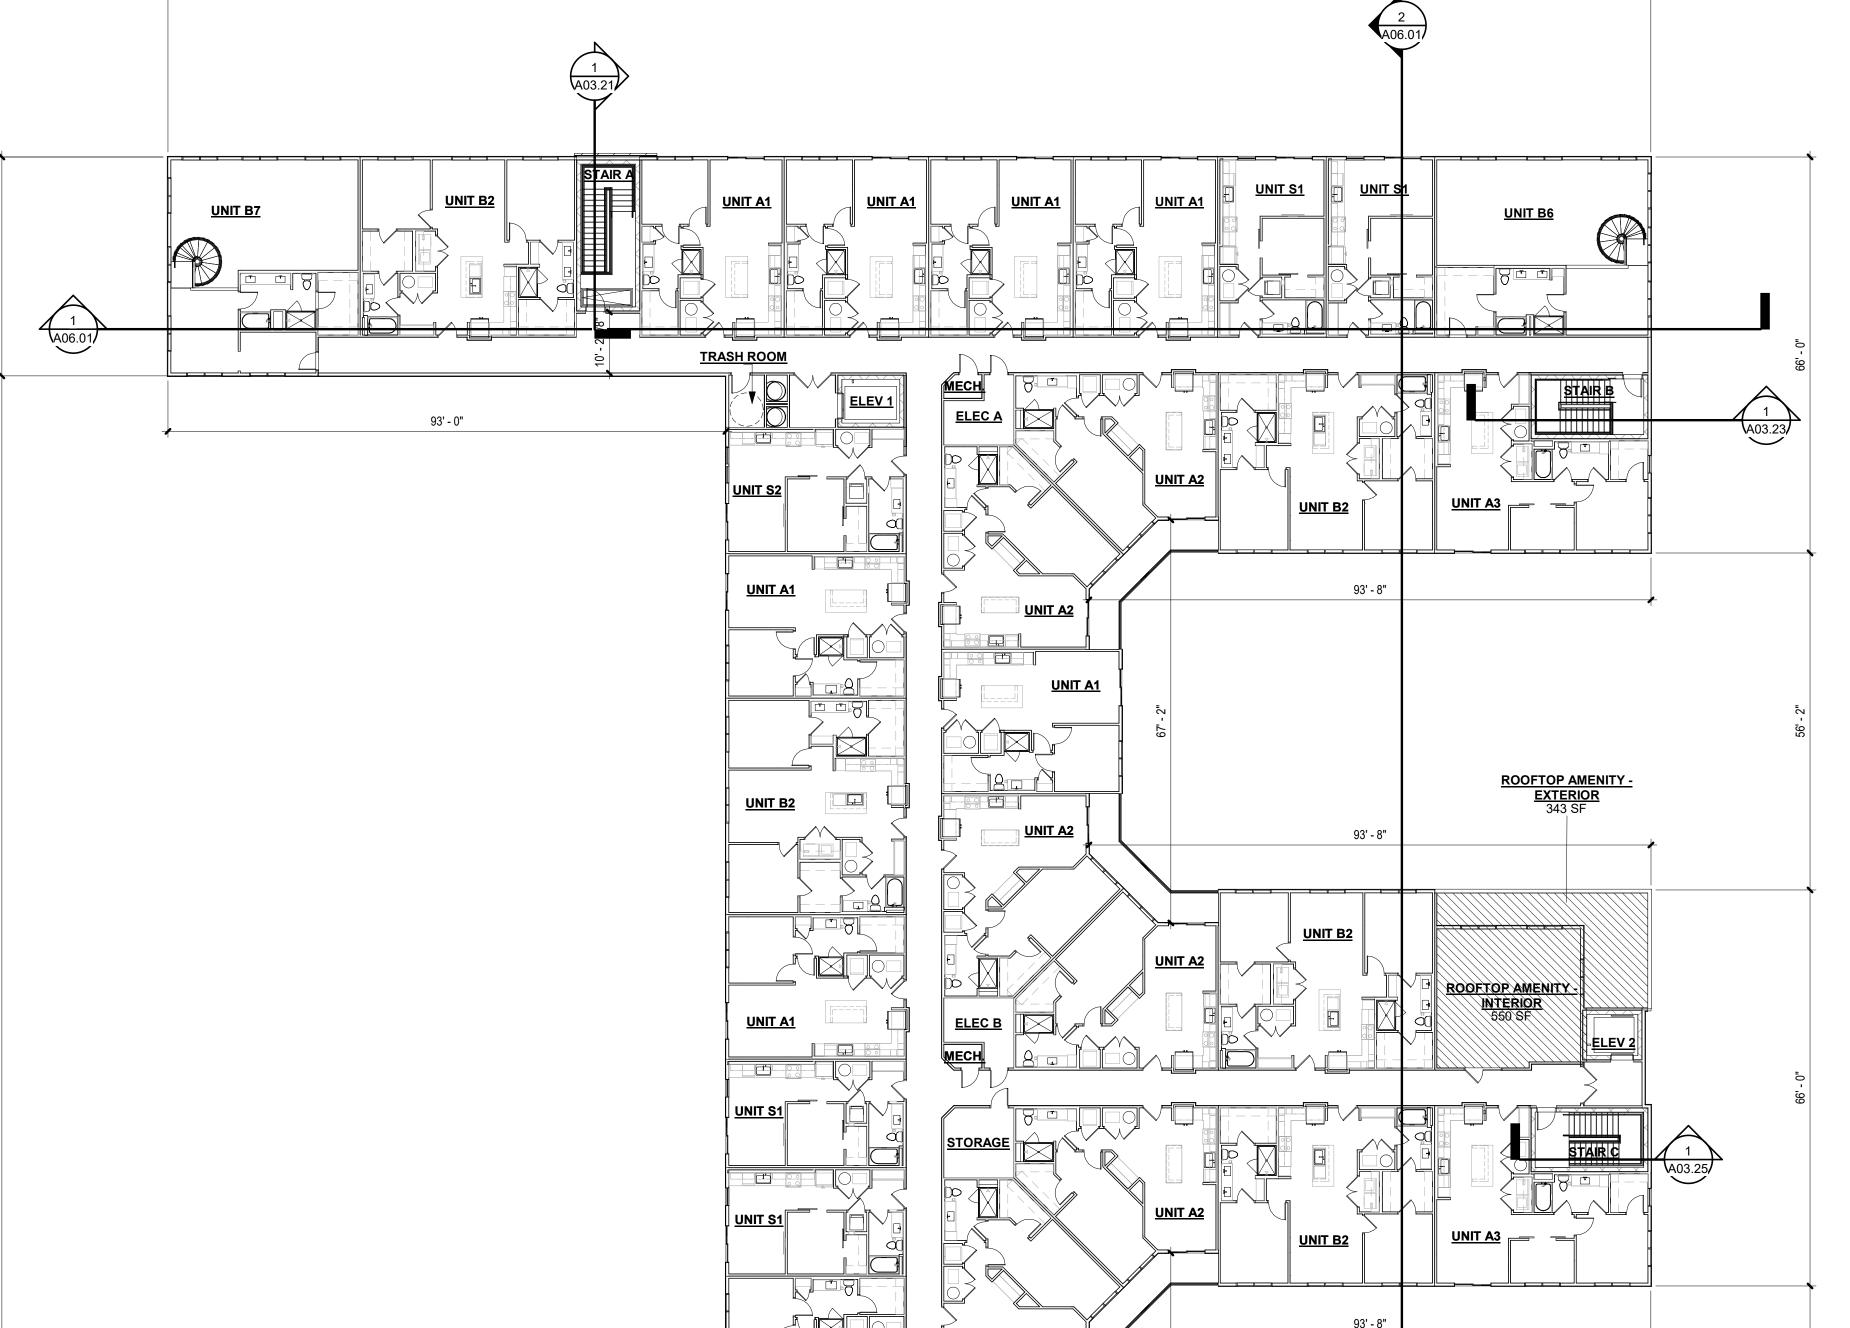
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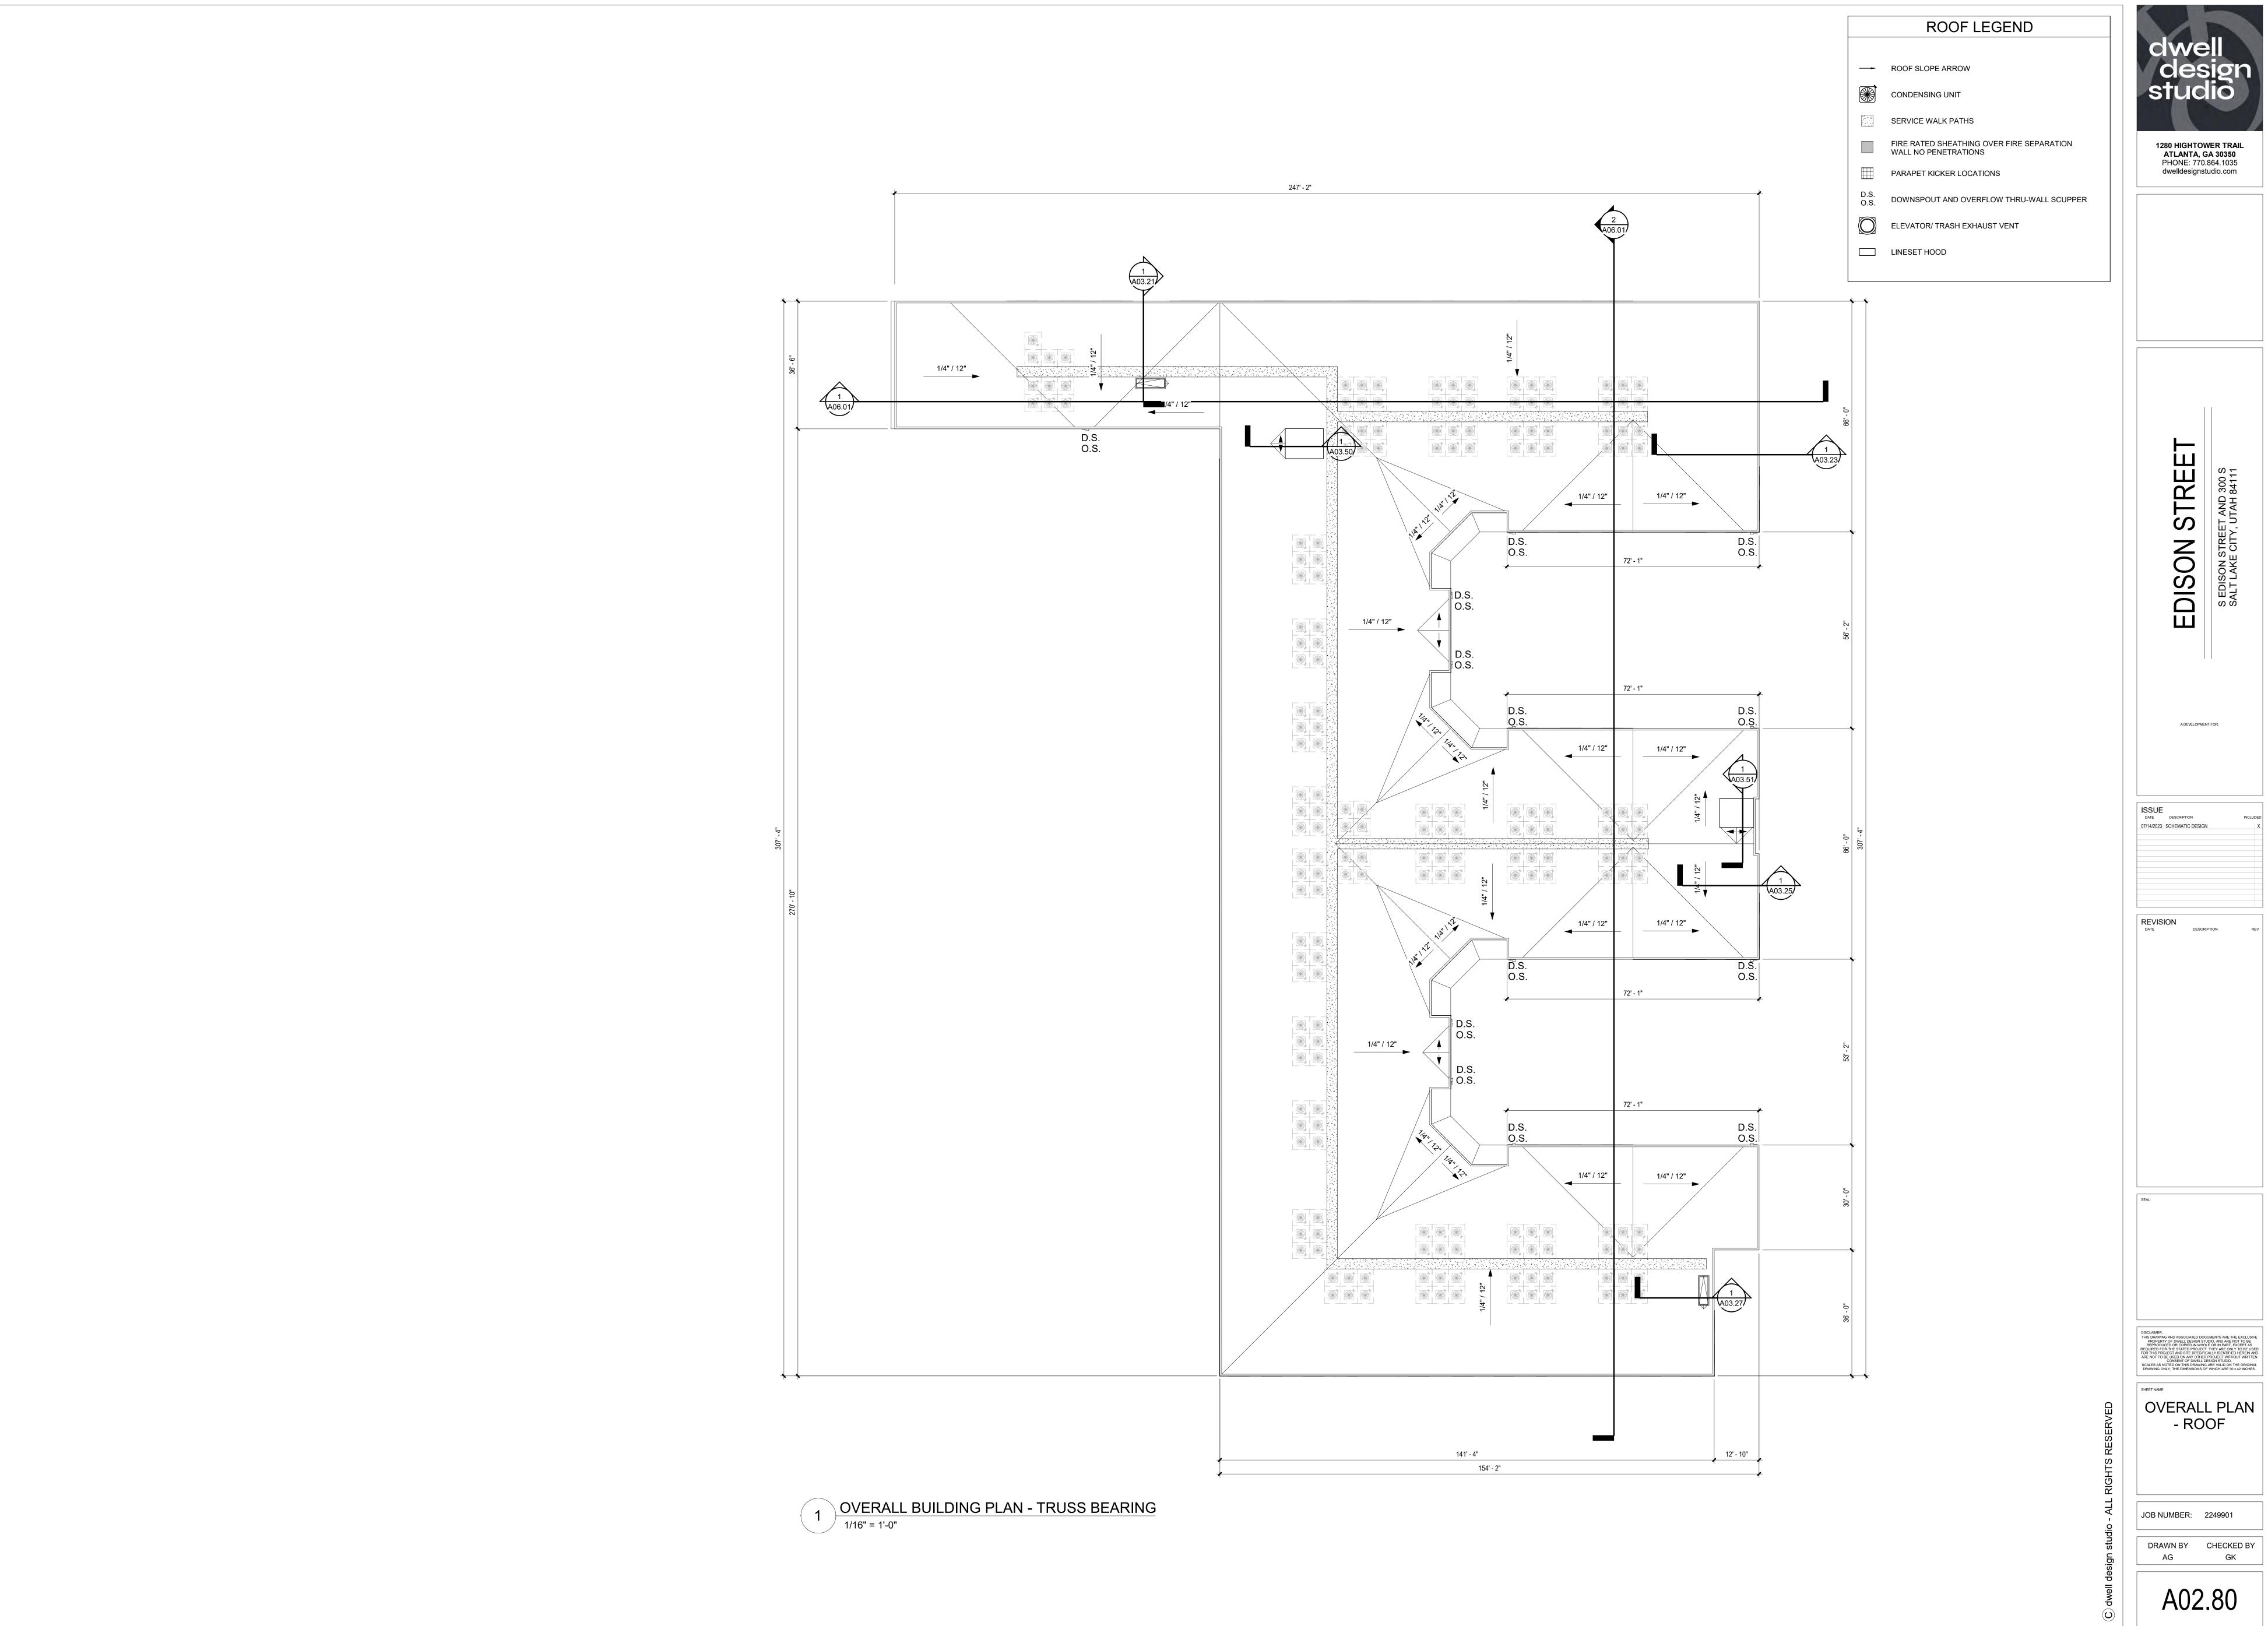
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1 OVERALL BUILDING PLAN - LEVEL 7
1/16" = 1'-0"







1 - 3D EXTERIOR VIEW

3D EXTERIOR VIEWS

JOB NUMBER: 2249901

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	EXTERIOR MATERIAL LEGEND											
M-01	BRICK COLOR:CHIPPEWA	M-03	BRICK COLOR:BLACK ICE	CPL-02	CEMENTITIOUS PANEL COLOR:SPECIAL GREY	СТВ	CEMENTITIOUS TRIM BOARD COLOR:SUMMER WHEAT	SF	STOREFRONT COLOR:DARK BRONZE	MM	MISCELLANEOUS METAL COLOR:DARK BRONZE	RETURN ALL MATERIALS AND COLORS TO INSIDE
M-02	BRICK COLOR:COUNTRY MANOR	CPL-01	CEMENTITIOUS PANEL COLOR:DARK GREY	CPL-03	CEMENTITIOUS PANEL COLOR:PERLE NOIR	CB01	CEMENTITIOUS BOARD AND BATTEN COLOR:WHITE	RA-01	ALUMINIUM RAILING COLOR:DARK BRONZE			CORNERS.



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SEE OVERALL SECTIONS FOR FLOOR TO FLOOR HEIGHTS AND LEVELS

OVERALL **ELEVATIONS**

JOB NUMBER: 2249901

A05.02



2 - NORTH ELEVATION

1/16" = 1'-0"



4 - SOUTH ELEVATION 1/16" = 1'-0"

	EXTERIOR MATERIAL LEGEND												
M-01	RICK M-0 OLOR:CHIPPEWA		CPL-02	CEMENTITIOUS PANEL COLOR:SPECIAL GREY	СТВ	TIOUS TRIM BOARD UMMER WHEAT	SF	STOREFRONT COLOR:DARK BRONZE	MM	MISCELLANEOUS METAL COLOR:DARK BRONZE			RETURN ALL MATERIALS AND COLORS TO INSIDE
M-02	RICK CPL- OLOR:COUNTRY MANOR	-01	ENTITIOUS PANEL CPL-03 DR:DARK GREY	CEMENTITIOUS PANEL COLOR:PERLE NOIR	CB01 COLOR:WH	TIOUS BOARD AND BATTEN 'HITE	RA-01	ALUMINIUM RAILING COLOR:DARK BRONZE					CORNERS.



1 - EAST ELEVATION

1/16" = 1'-0"



3 - WEST ELEVATION
1/16" = 1'-0"

SEE OVERALL SECTIONS FOR FLOOR TO FLOOR HEIGHTS AND LEVELS

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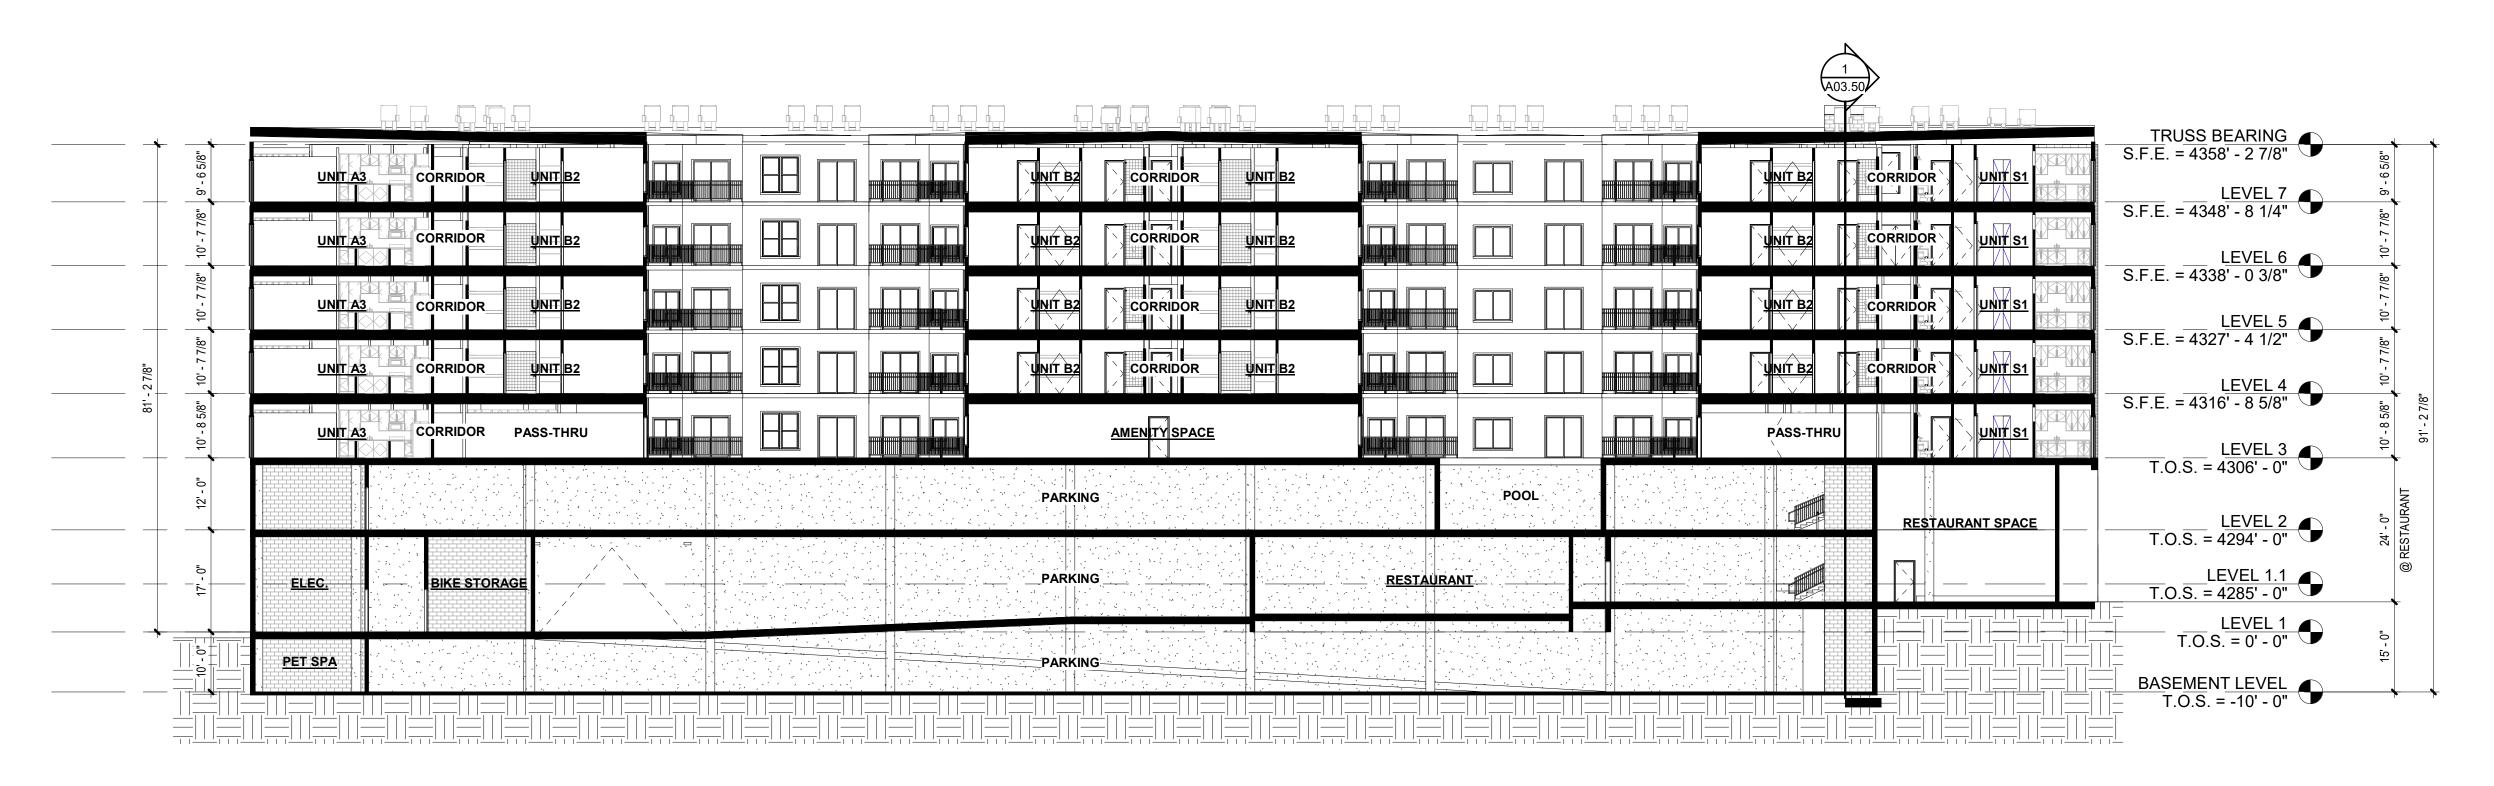
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OVERALL ELEVATIONS


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2 OVERALL BUILDING SECTION 2
1/16" = 1'-0"



1 OVERALL BUILDING SECTION 1
1/16" = 1'-0"

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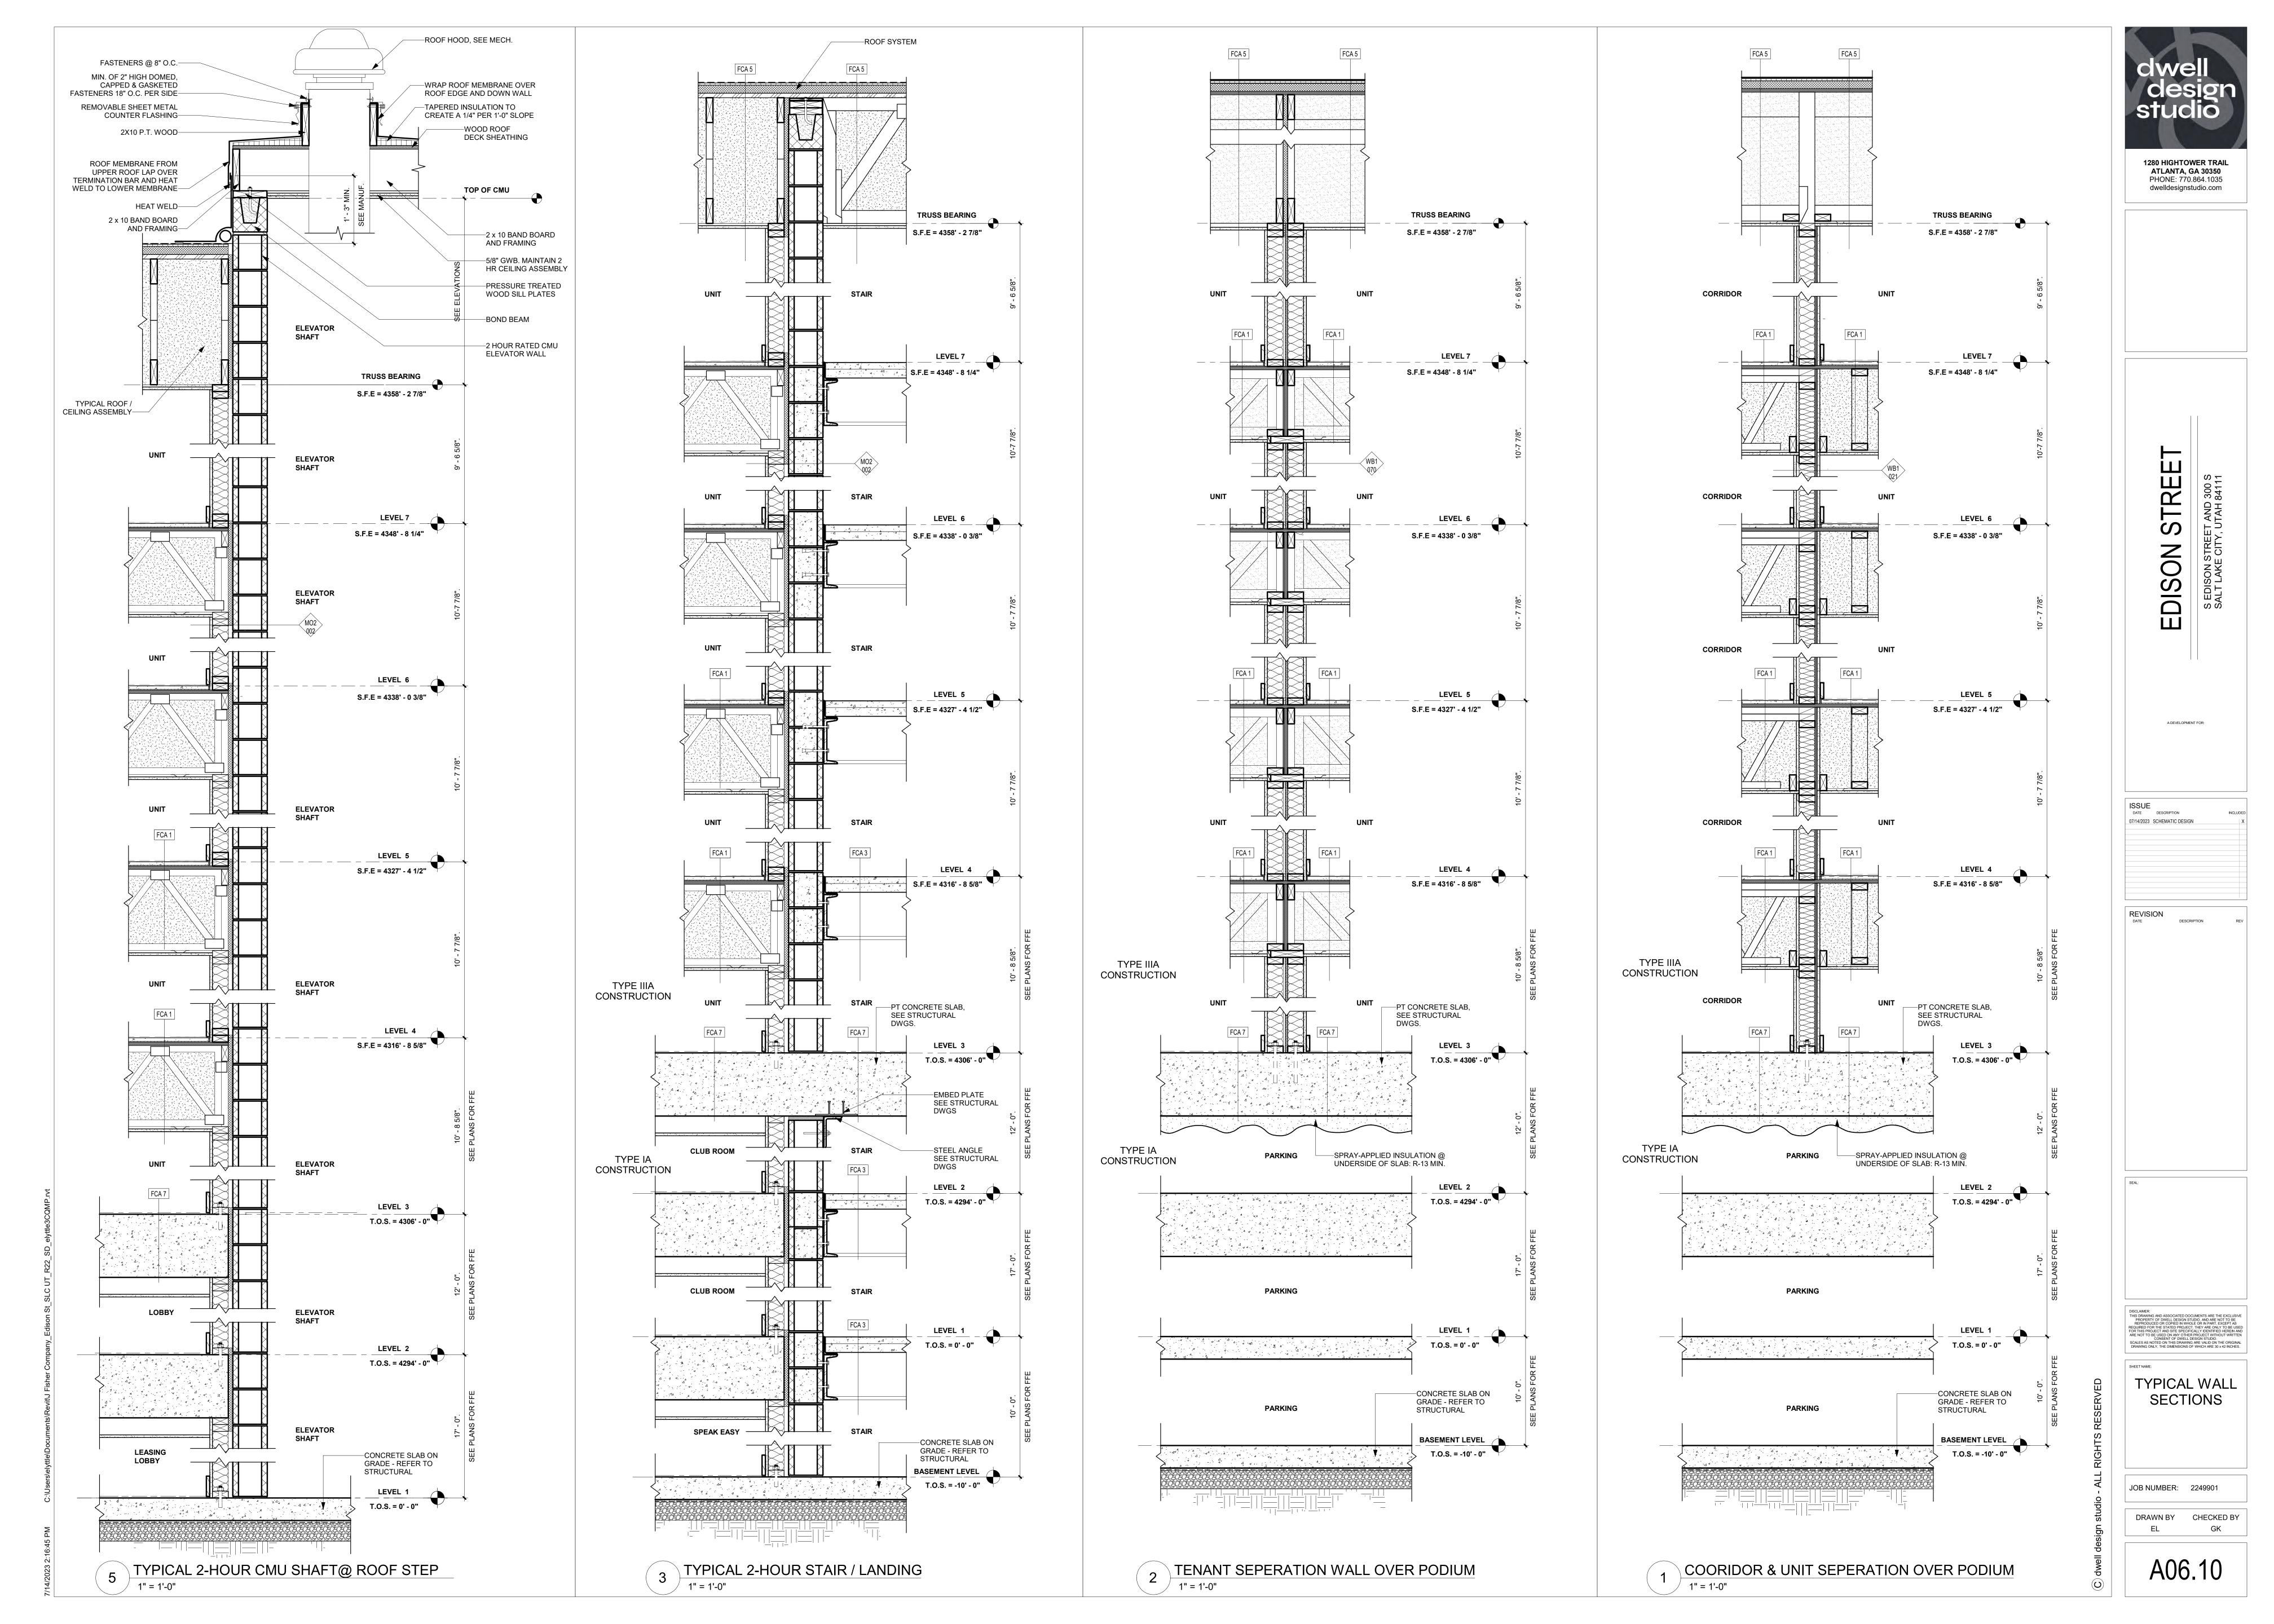
OVERALL
BUILDING
SECTIONS


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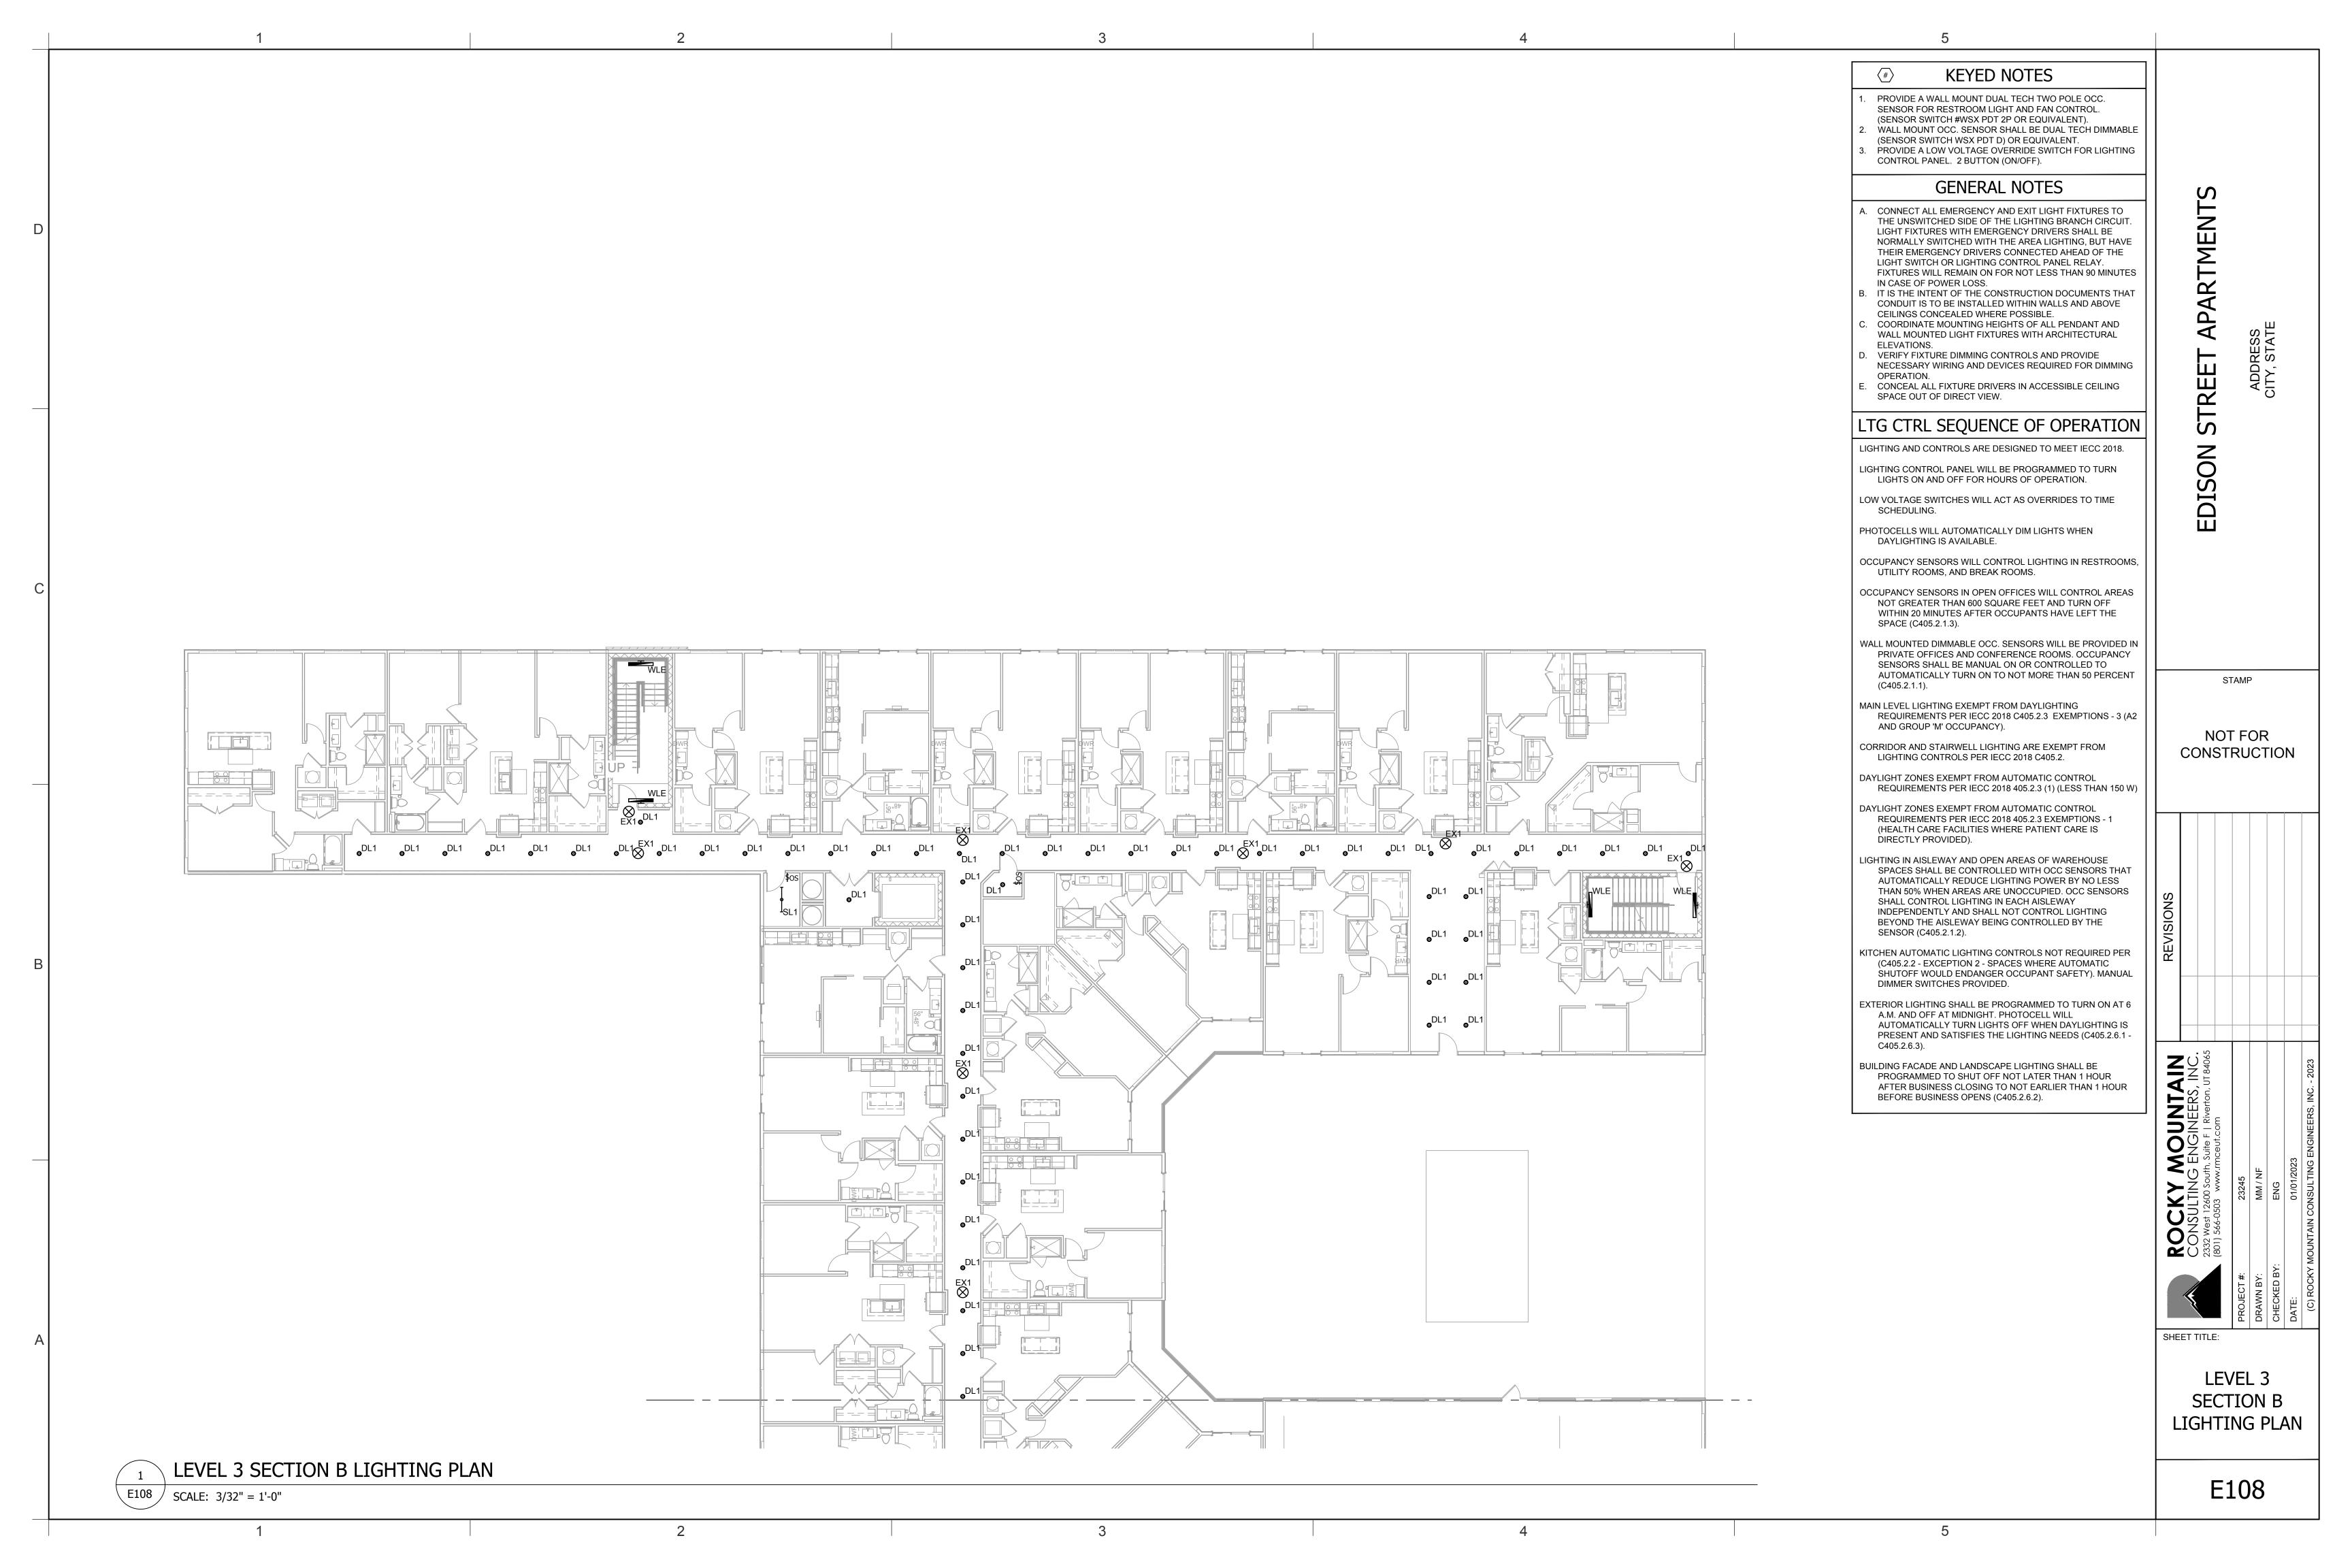
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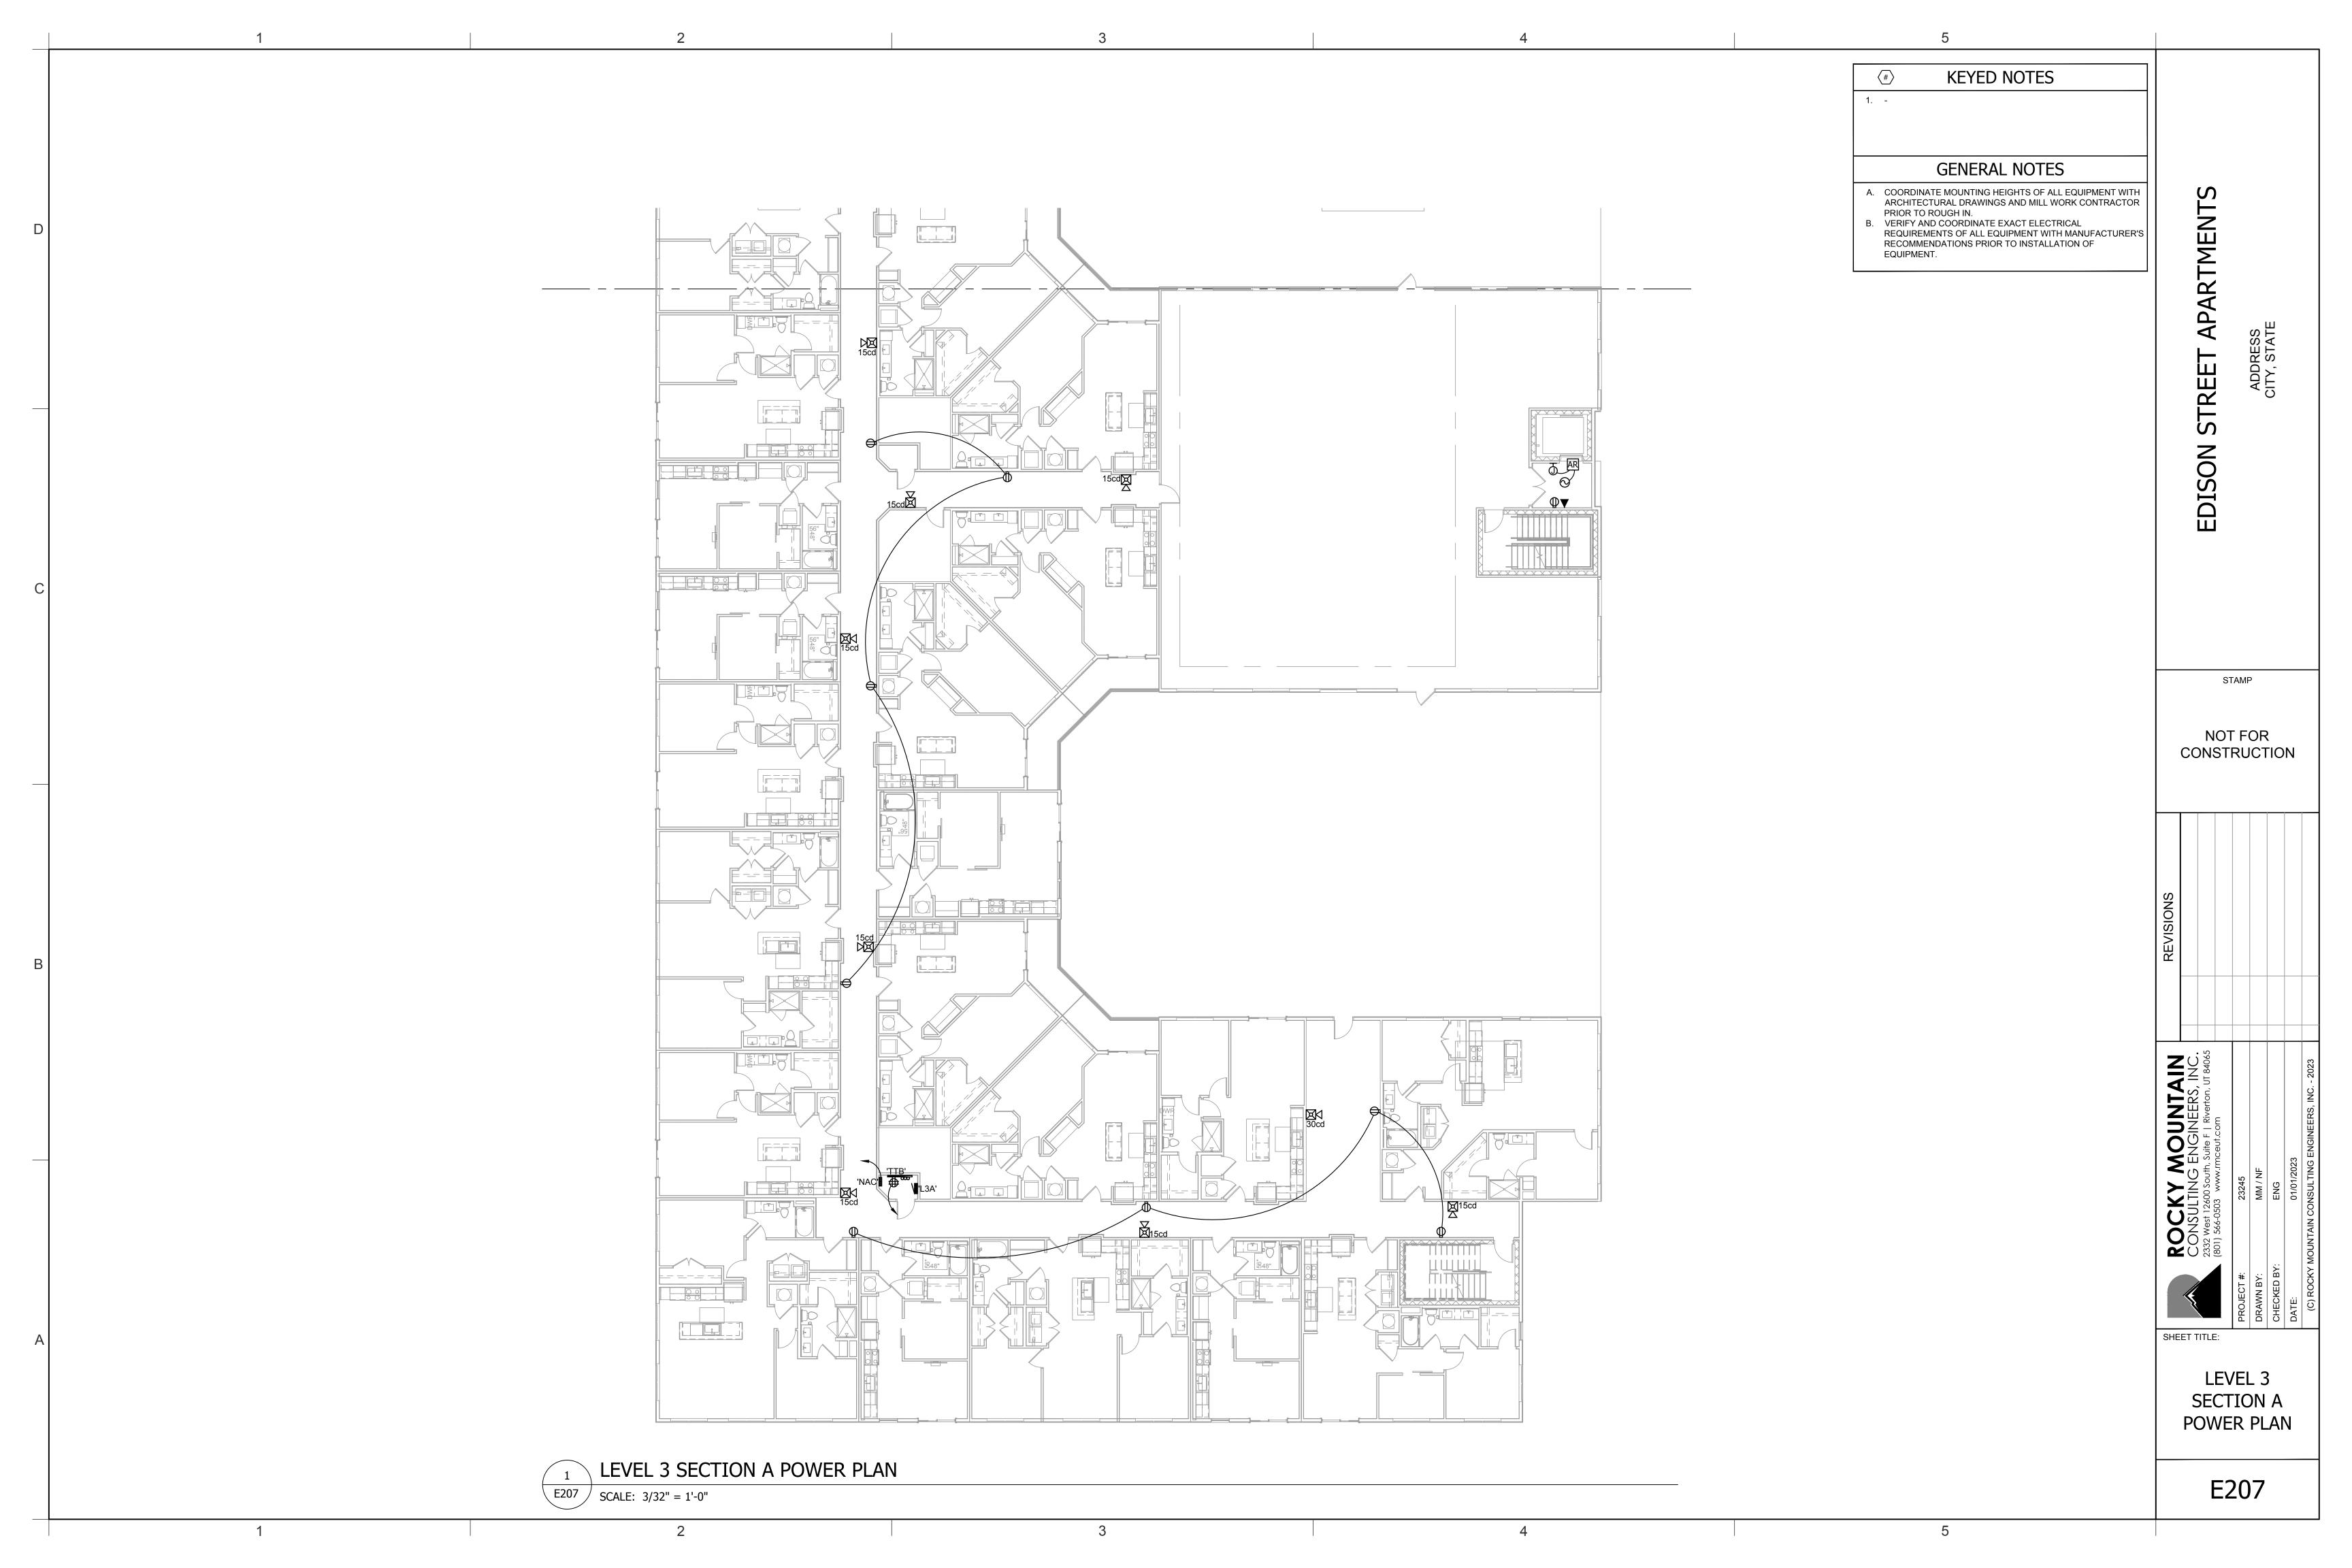
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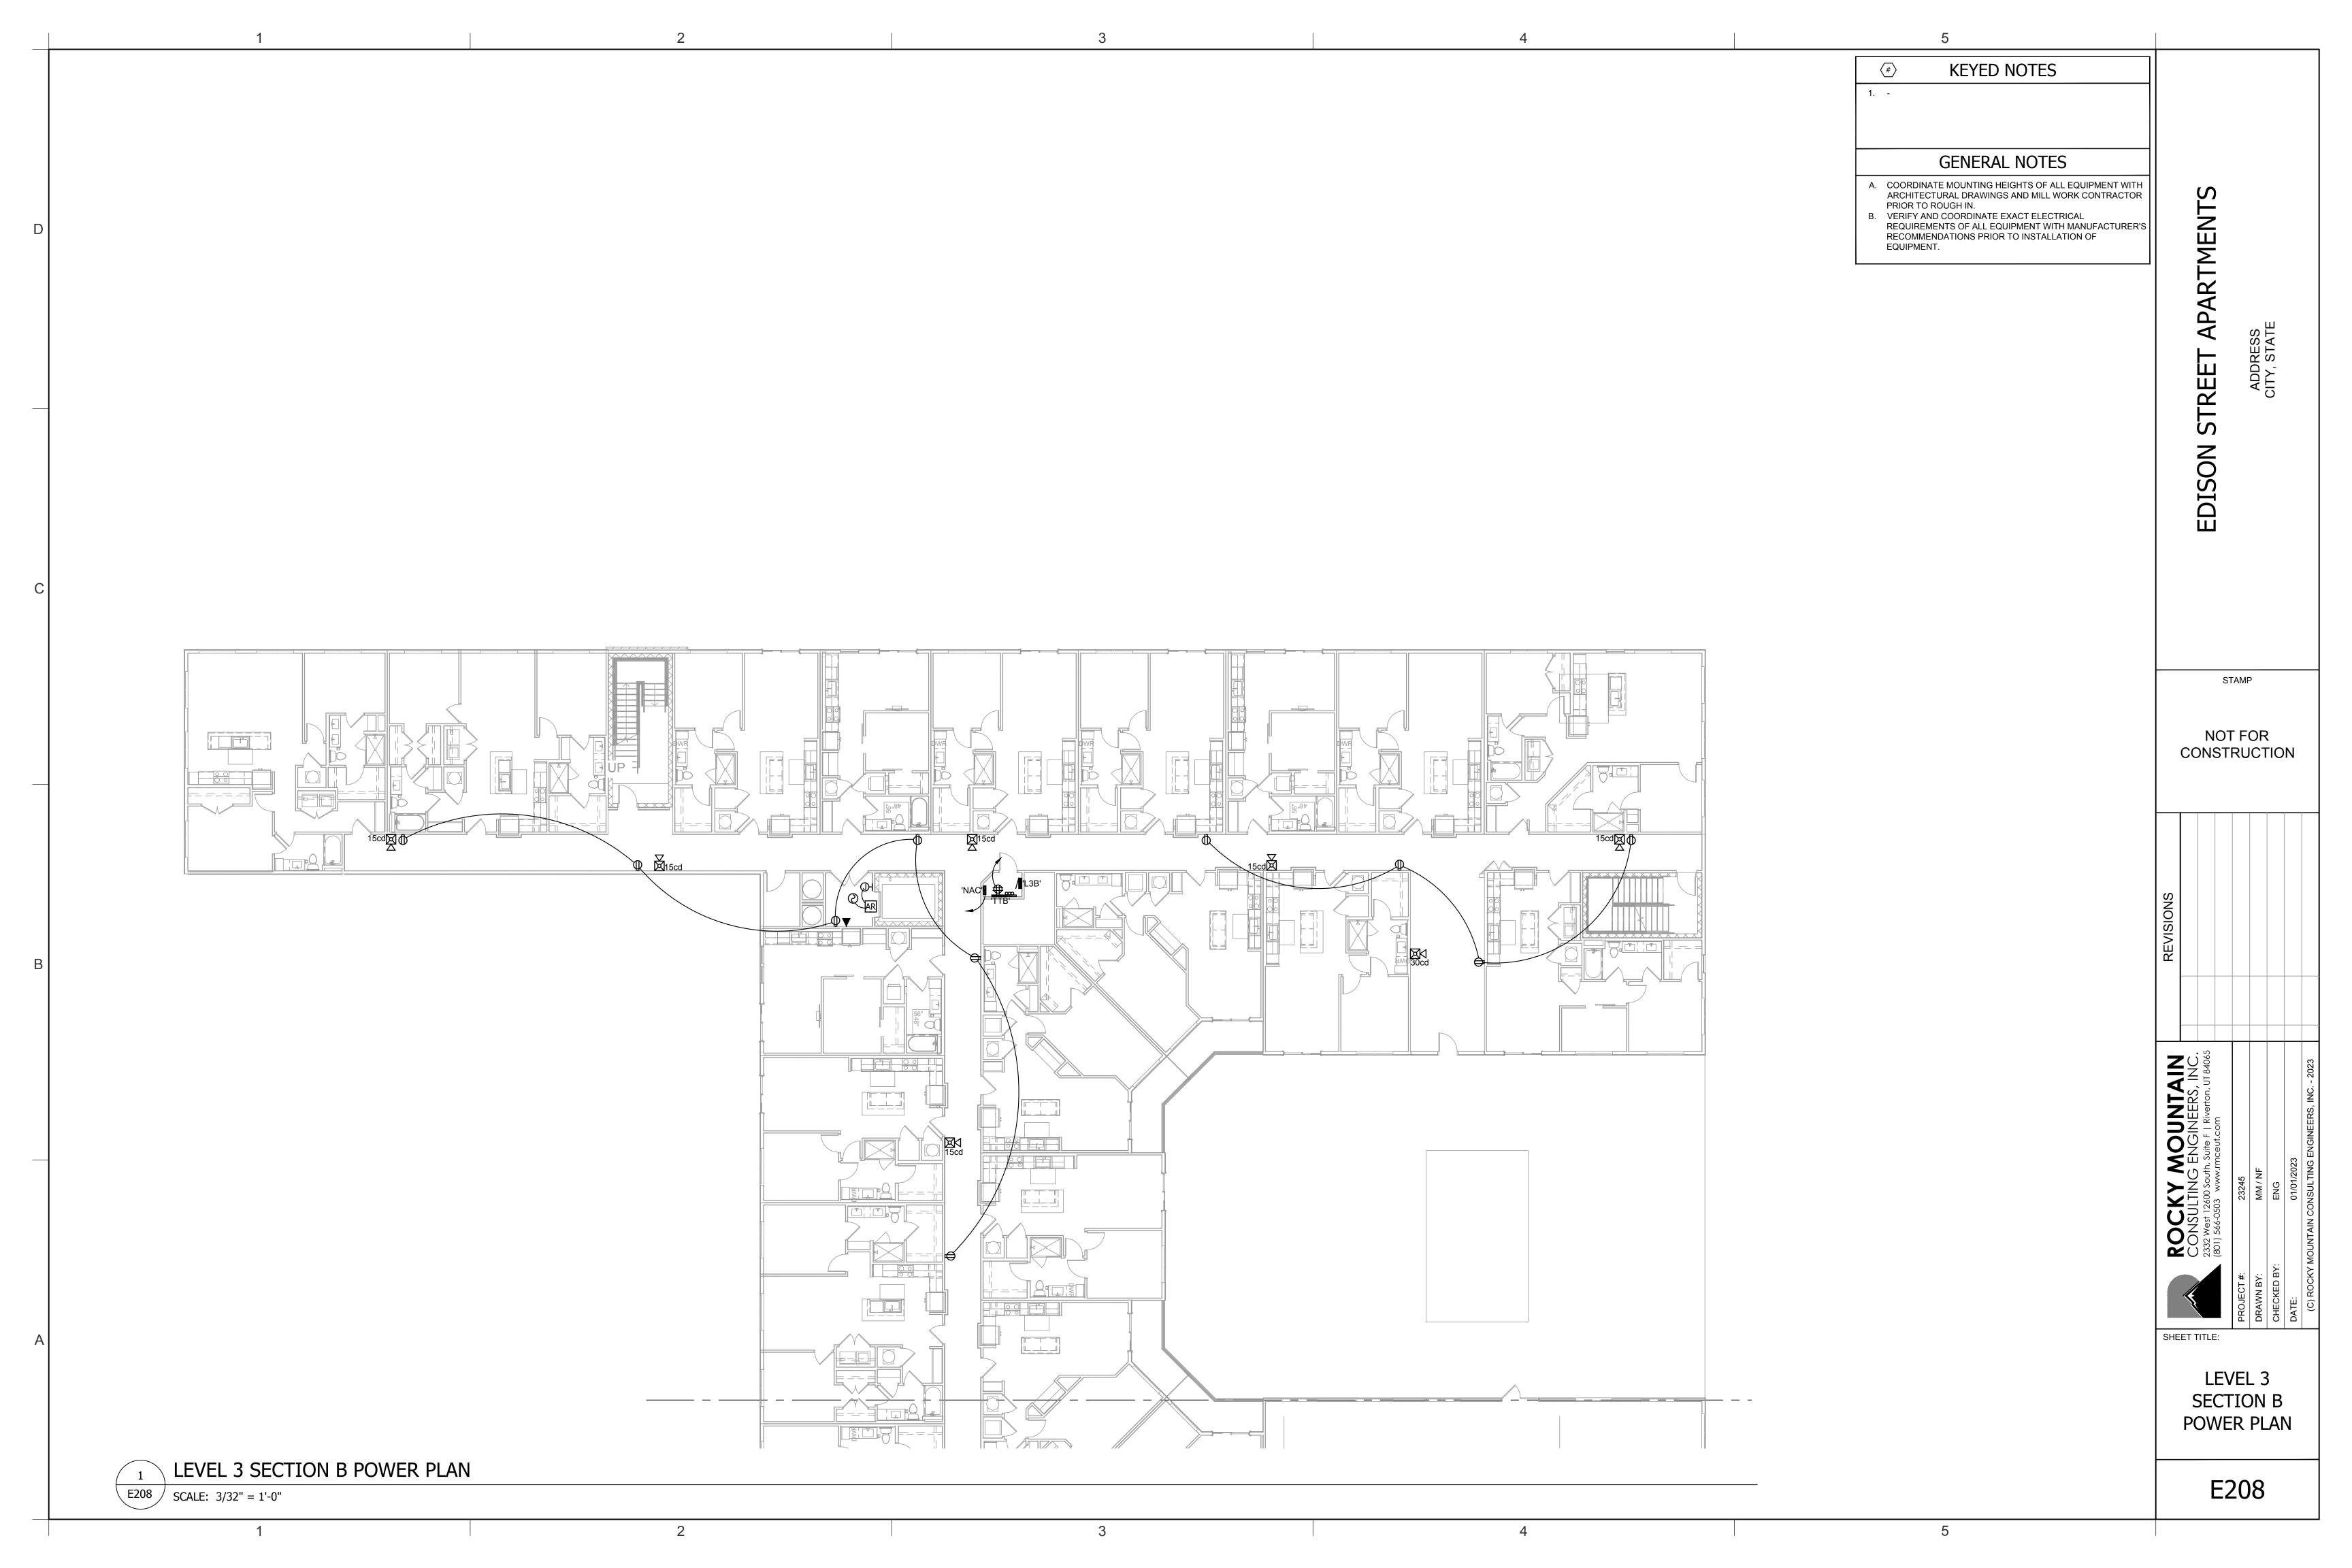
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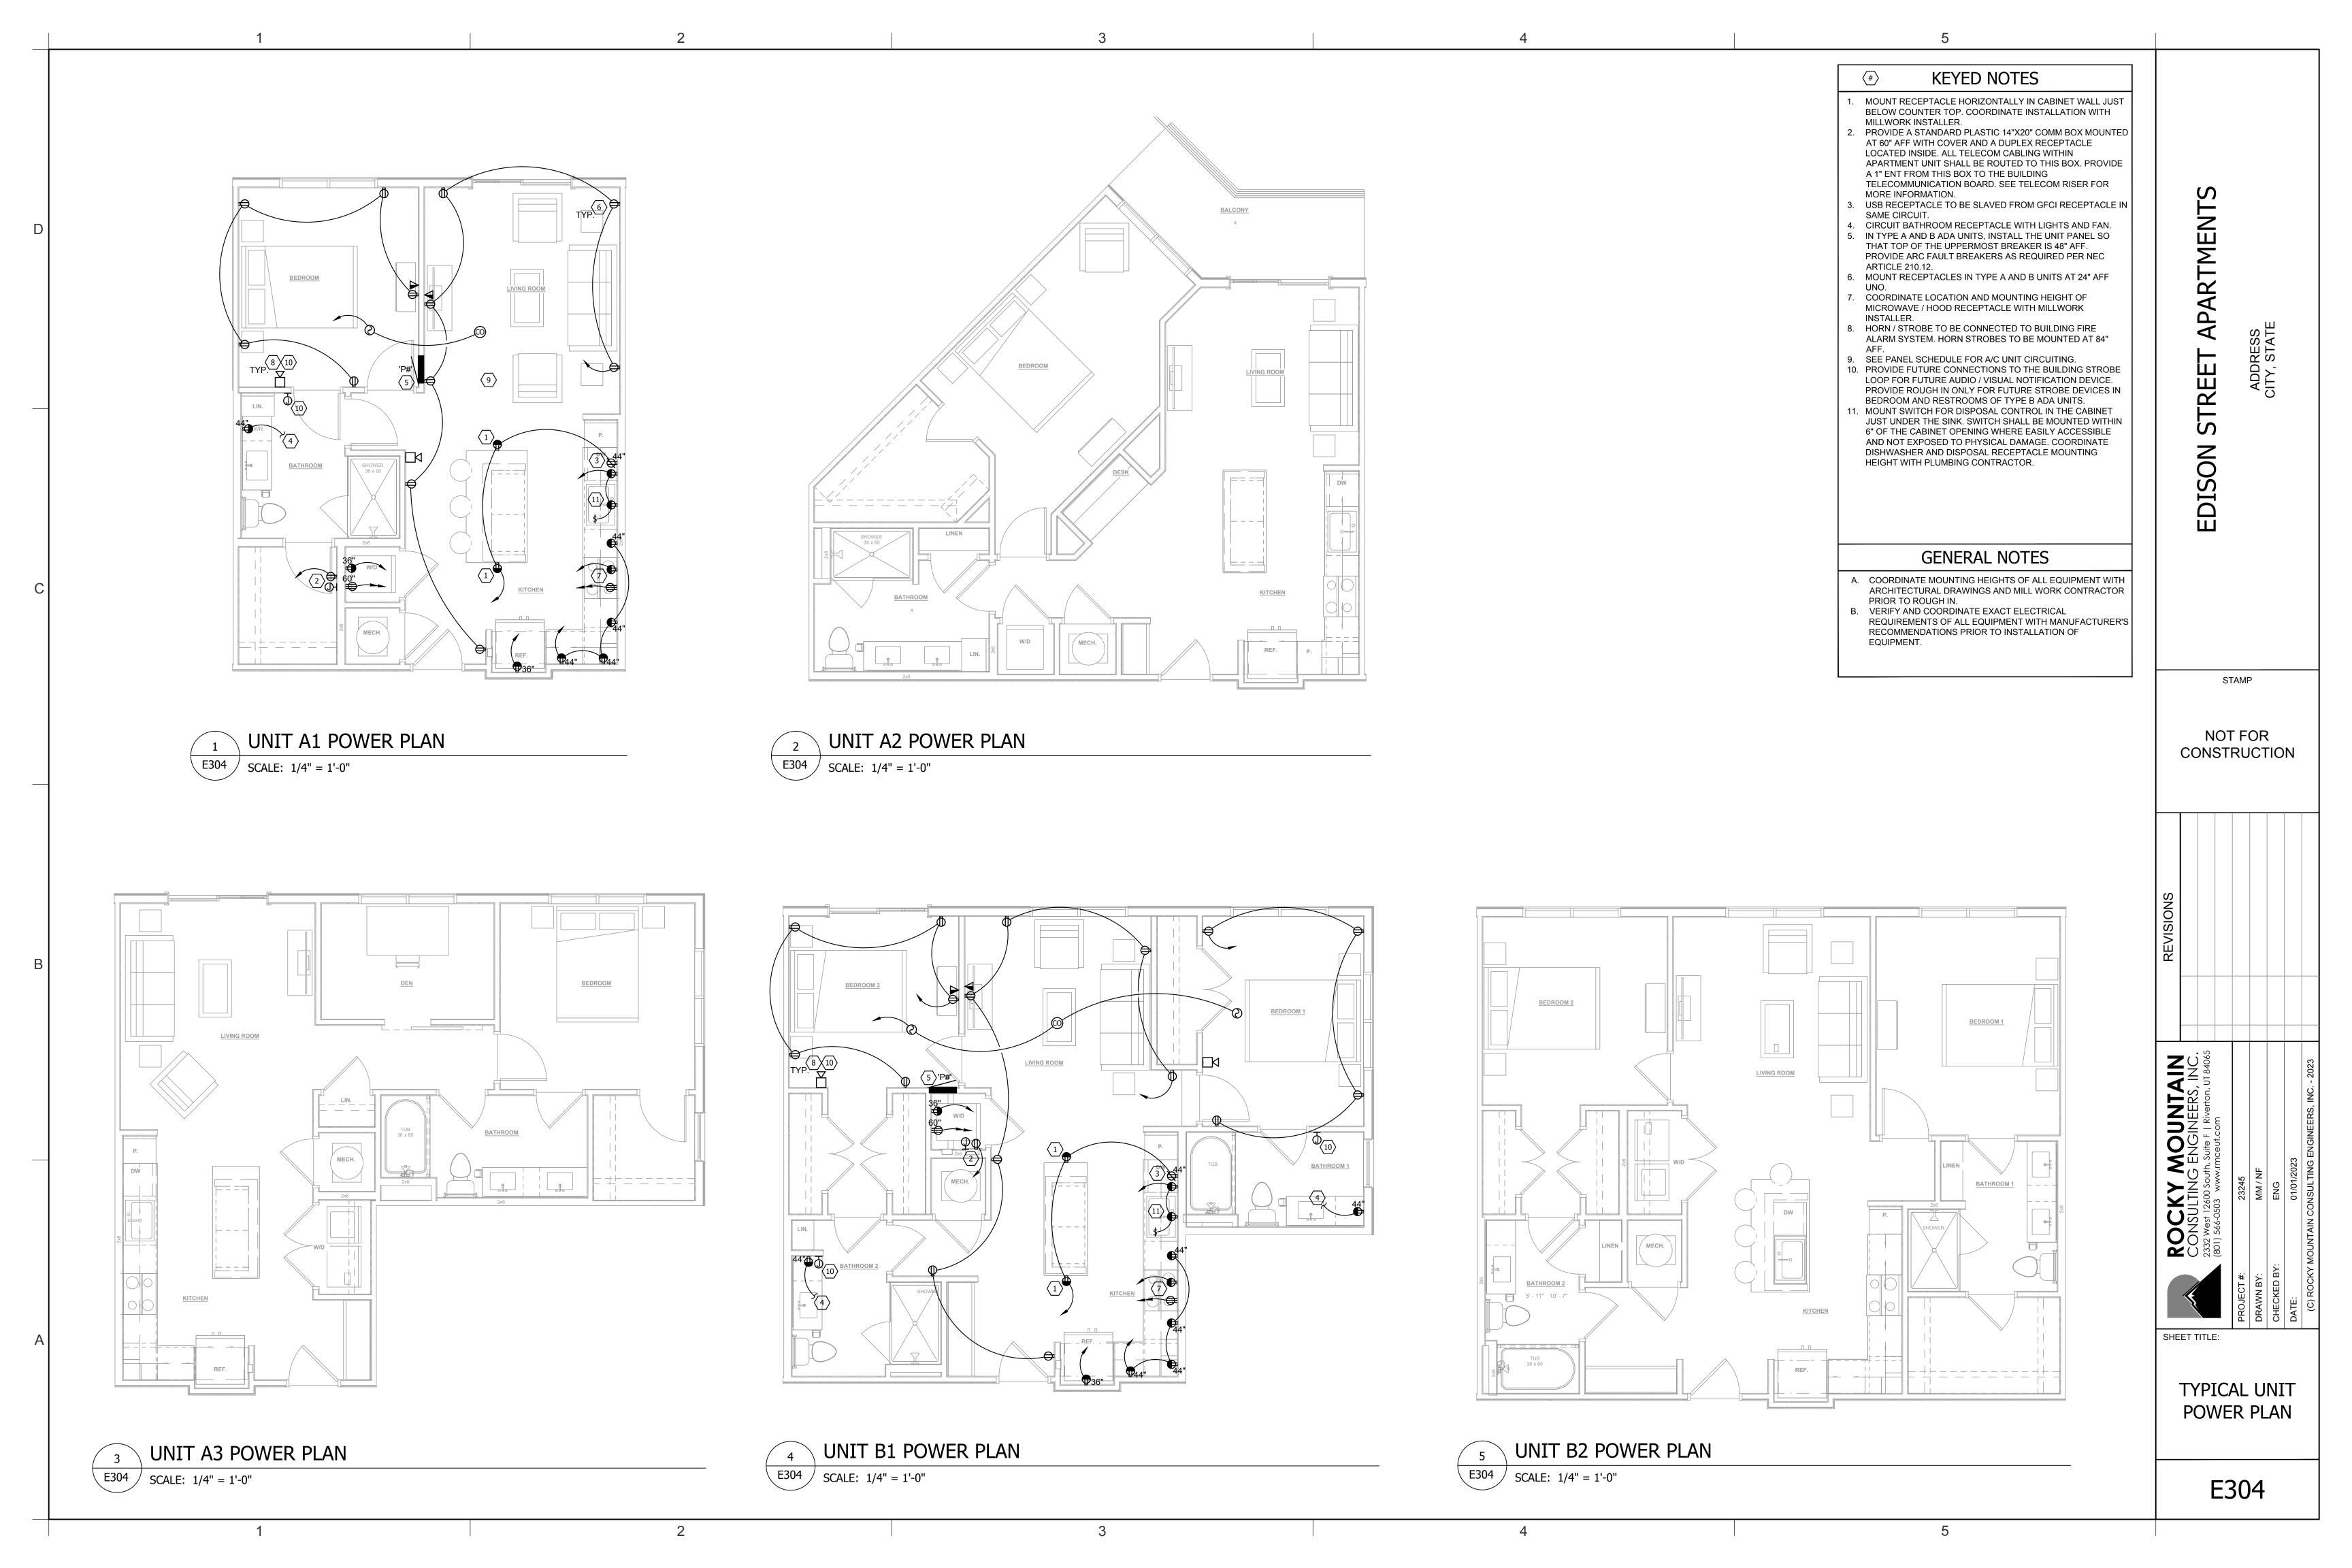


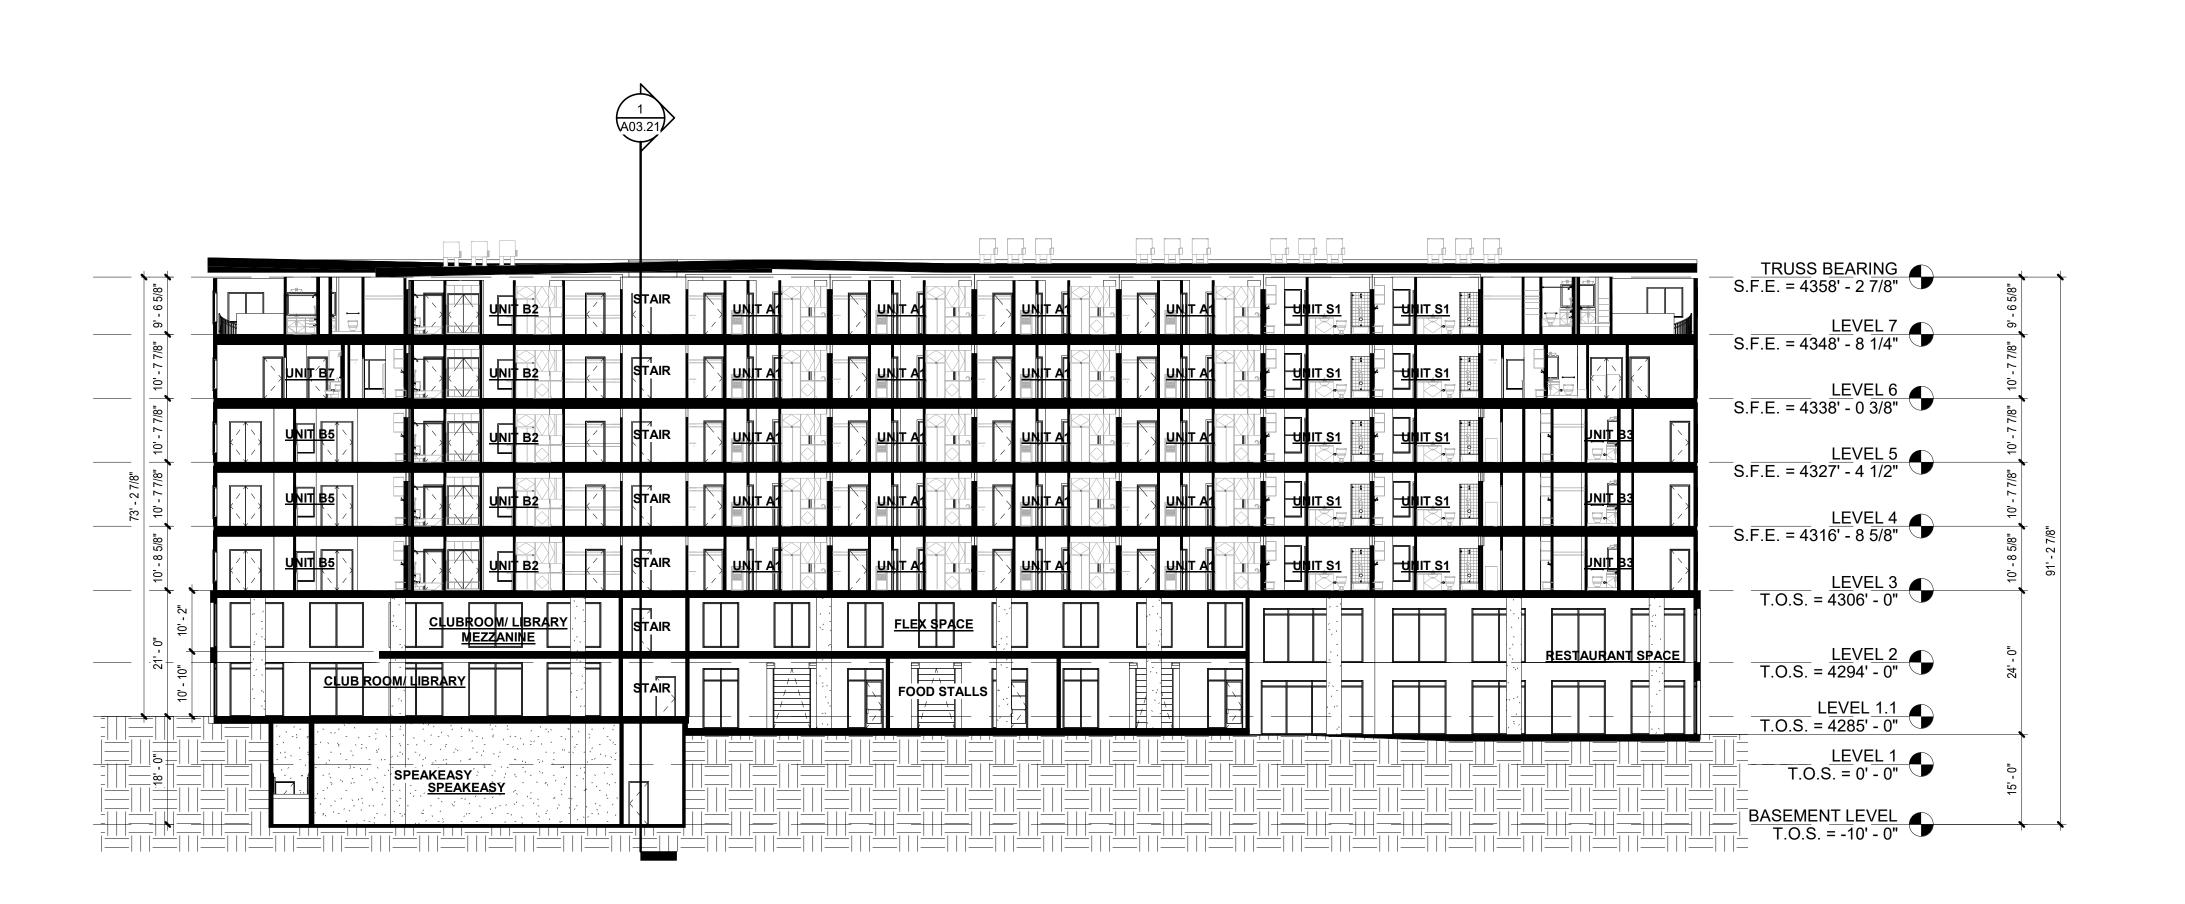








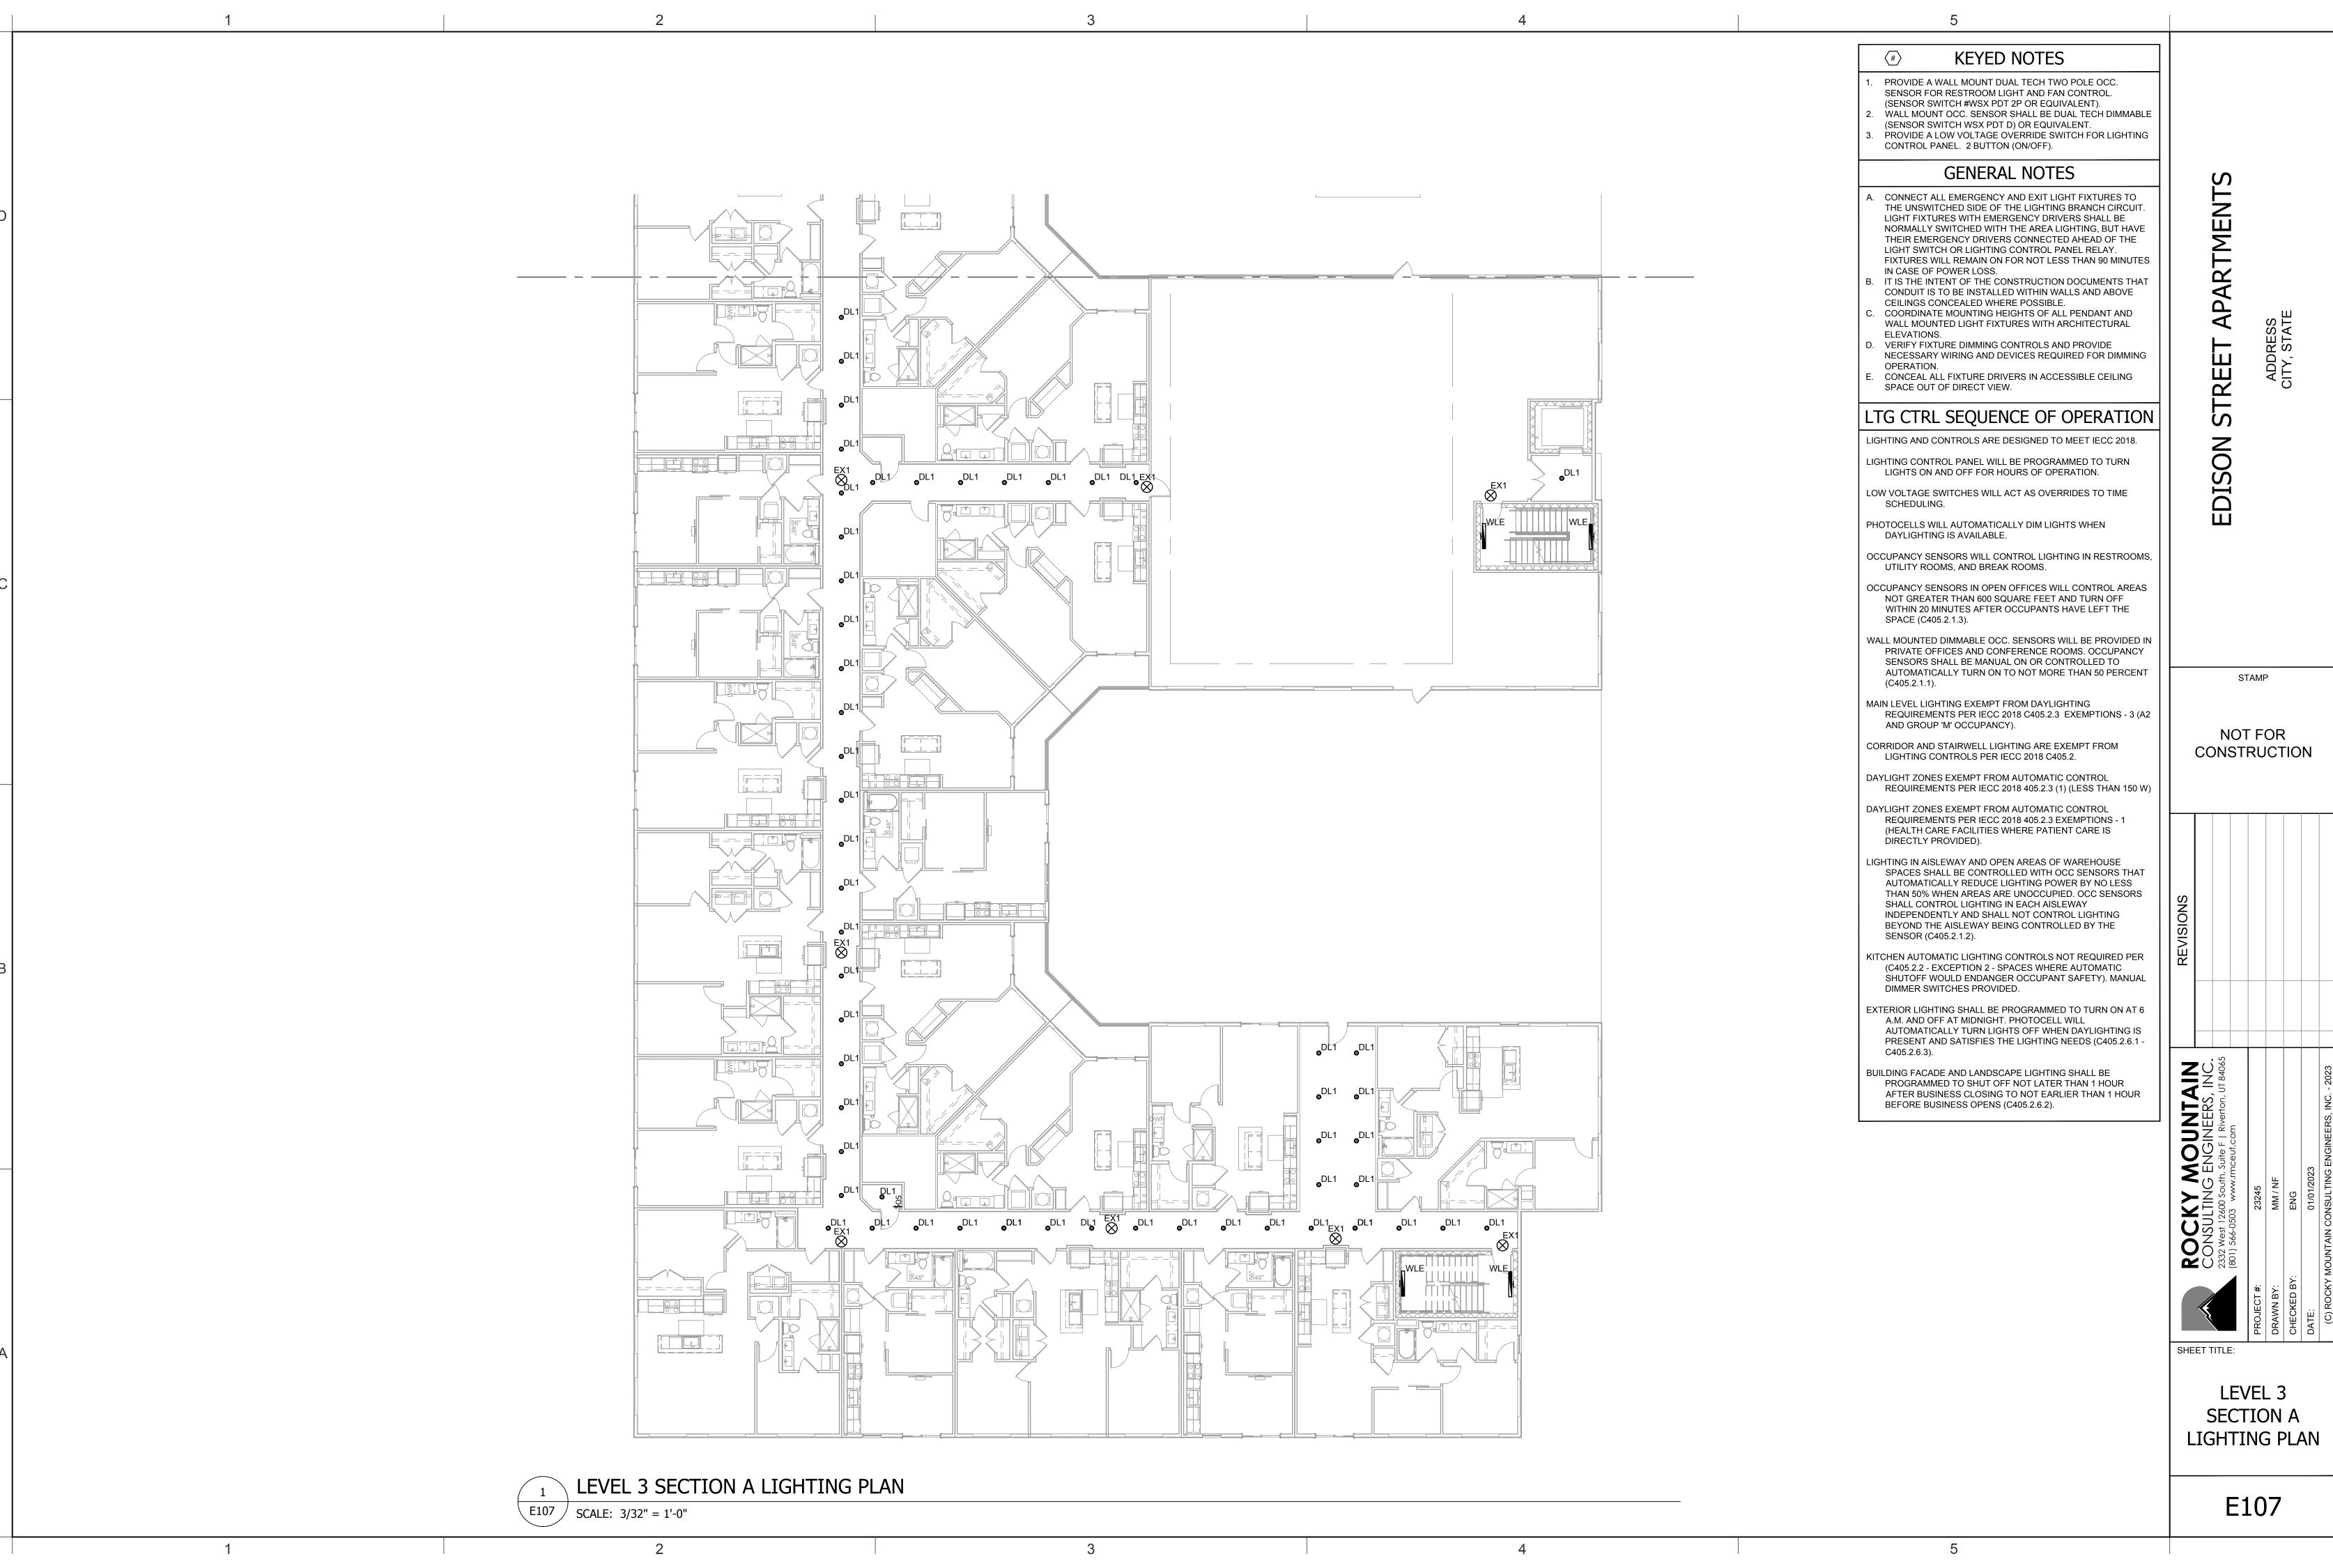


DINING SPACE BEDROOM 2 12' - 5" 10' - 6" KITCHEN BATHROOM 2 _____ BATHROOM 1 BEDROOM 1

UNIT B3 POWER PLAN $\overline{\text{E305}}$ SCALE: 1/4" = 1'-0"

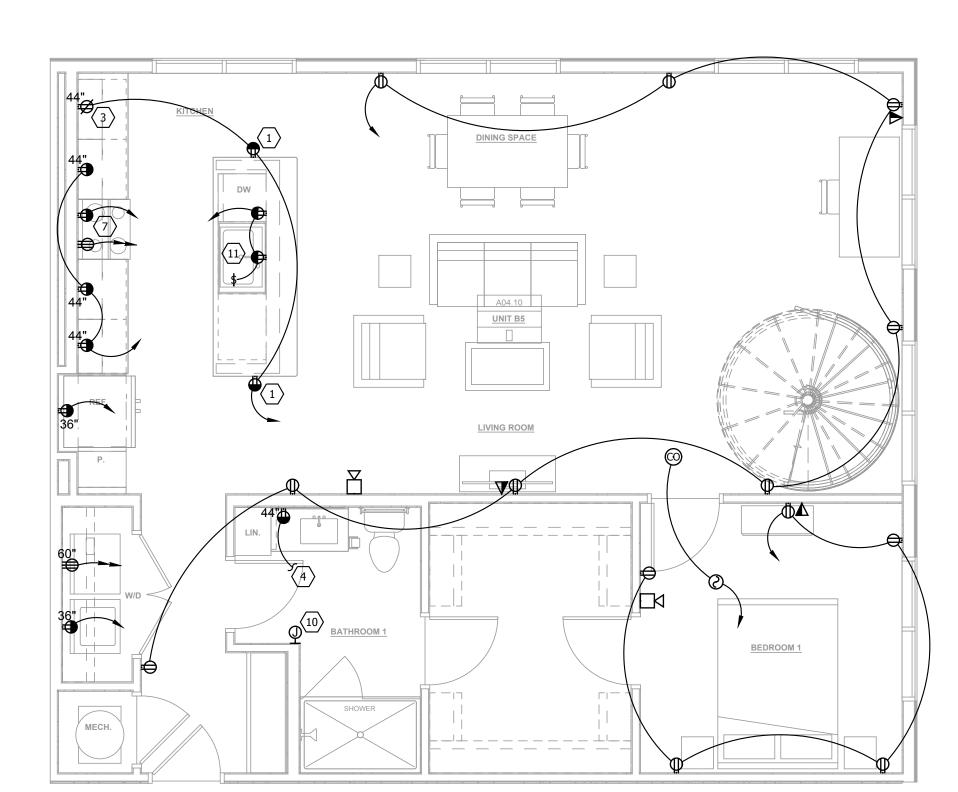


UNIT B5 LEVEL 1 POWER PLAN E305 SCALE: 1/4" = 1'-0"

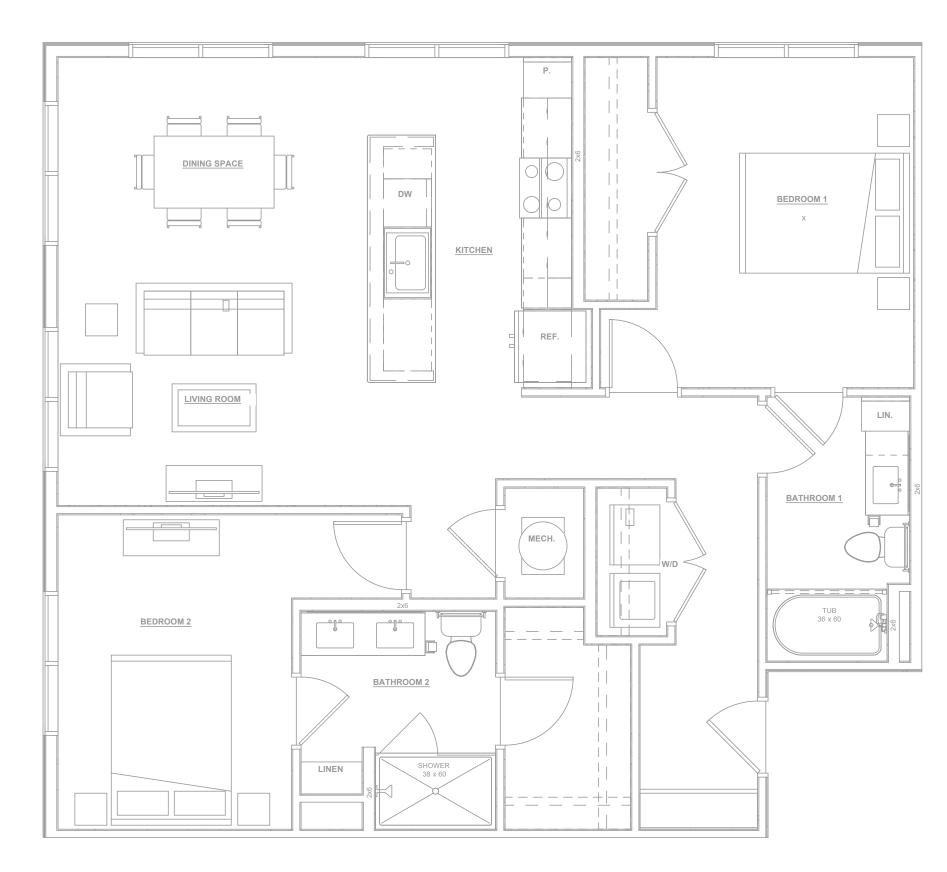

UNIT B4 POWER PLAN

 $\overline{\text{E305}}$ SCALE: 1/4" = 1'-0"

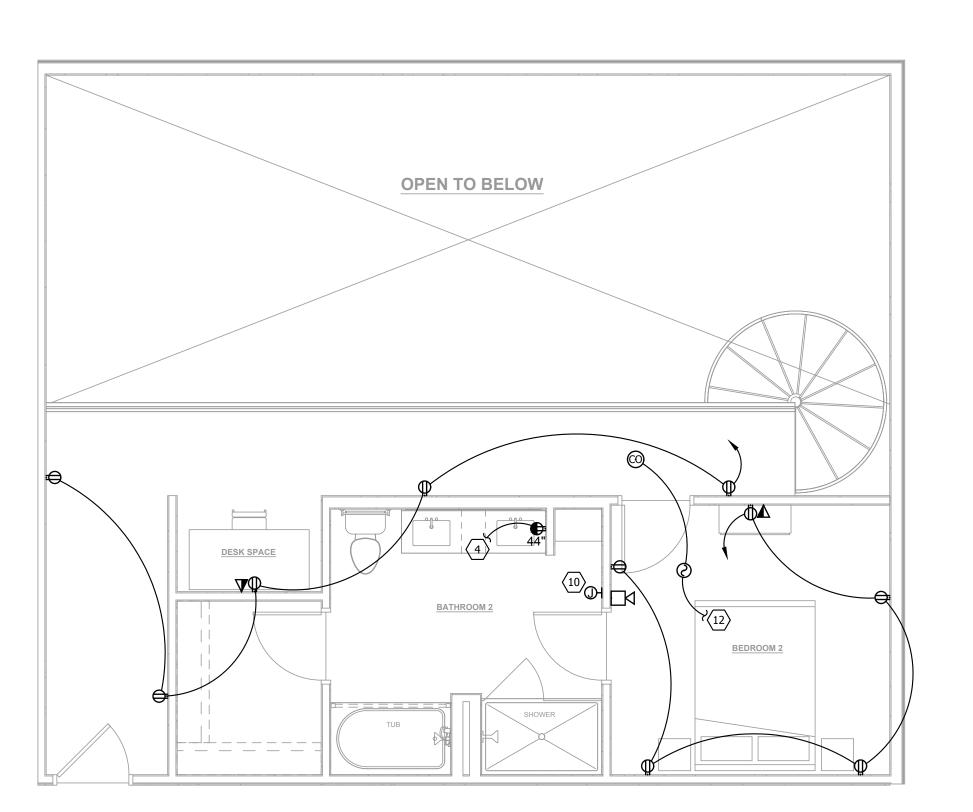

UNIT B5 LEVEL 2 POWER PLAN

E305 | SCALE: 1/4" = 1'-0"

KEYED NOTES

- MOUNT RECEPTACLE HORIZONTALLY IN CABINET WALL JUST BELOW COUNTER TOP. COORDINATE INSTALLATION WITH MILLWORK INSTALLER.
- PROVIDE A STANDARD PLASTIC 14"X20" COMM BOX MOUNTED AT 60" AFF WITH COVER AND A DUPLEX RECEPTACLE LOCATED INSIDE. ALL TELECOM CABLING WITHIN APARTMENT UNIT SHALL BE ROUTED TO THIS BOX. PROVIDE A 1" ENT FROM THIS BOX TO THE BUILDING
- USB RECEPTACLE TO BE SLAVED FROM GFCI RECEPTACLE IN
- THAT TOP OF THE UPPERMOST BREAKER IS 48" AFF. PROVIDE ARC FAULT BREAKERS AS REQUIRED PER NEC
- 6. MOUNT RECEPTACLES IN TYPE A AND B UNITS AT 24" AFF
- COORDINATE LOCATION AND MOUNTING HEIGHT OF
- SEE PANEL SCHEDULE FOR A/C UNIT CIRCUITING. 10. PROVIDE FUTURE CONNECTIONS TO THE BUILDING STROBE
- . MOUNT SWITCH FOR DISPOSAL CONTROL IN THE CABINET JUST UNDER THE SINK. SWITCH SHALL BE MOUNTED WITHIN 6" OF THE CABINET OPENING WHERE EASILY ACCESSIBLE AND NOT EXPOSED TO PHYSICAL DAMAGE. COORDINATE DISHWASHER AND DISPOSAL RECEPTACLE MOUNTING
- HEIGHT WITH PLUMBING CONTRACTOR. 12. CIRCUIT TO LOWER LEVEL FIRE ALARM SYSTEM.

GENERAL NOTES

- A. COORDINATE MOUNTING HEIGHTS OF ALL EQUIPMENT WITH ARCHITECTURAL DRAWINGS AND MILL WORK CONTRACTOR PRIOR TO ROUGH IN.
- B. VERIFY AND COORDINATE EXACT ELECTRICAL REQUIREMENTS OF ALL EQUIPMENT WITH MANUFACTURER'S RECOMMENDATIONS PRIOR TO INSTALLATION OF EQUIPMENT.

APARTMENTS

STREET

EDISON

ADDRESS CITY, STATE

NOT FOR CONSTRUCTION

STAMP

TYPICAL UNIT POWER PLAN

- TELECOMMUNICATION BOARD. SEE TELECOM RISER FOR MORE INFORMATION.
- SAME CIRCUIT. CIRCUIT BATHROOM RECEPTACLE WITH LIGHTS AND FAN. . IN TYPE A AND B ADA UNITS, INSTALL THE UNIT PANEL SO
- ARTICLE 210.12.
- MICROWAVE / HOOD RECEPTACLE WITH MILLWORK INSTALLER.
- B. HORN / STROBE TO BE CONNECTED TO BUILDING FIRE ALARM SYSTEM. HORN STROBES TO BE MOUNTED AT 84"
- LOOP FOR FUTURE AUDIO / VISUAL NOTIFICATION DEVICE. PROVIDE ROUGH IN ONLY FOR FUTURE STROBE DEVICES IN BEDROOM AND RESTROOMS OF TYPE B ADA UNITS.

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